

AUDUBON LOUISIANA NATURE CENTER

11000 LAKE FOREST BLVD, NEW ORLEANS, 70128


OWNER:
 AUDUBON NATURE INSTITUTE
 5600 MAGAZINE ST
 NEW ORLEANS, LA 70118

ARCHITECT:
 BILLES PARTNERS, LLC
 1055 ST CHARLES AVE, SUITE 220
 NEW ORLEANS, LA 70130

TOTAL SITE AREA: APPROX. 3,800,000 SF
BUILDING AREA: 13,500 SF
DECK AREA: 7,000 SF

PROJECT SUMMARY

The Audubon Nature Center is situated on approximately 83 acres of bottom land hardwood and bald cypress-tupelo swamp habitat surrounded by urban development. The center will provide nature based environmental education and outdoor recreational opportunities benefitting the Greater New Orleans Metro area and surrounding Parishes/Counties. The scope of the project consists of demolition of the existing Gift Shop and boardwalk. The Scope of construction consists of a replacement facility combining the programs of those buildings demolished, the renovation of an existing botany center and maintenance building, a replacement boardwalk, and extension of the service drive, new bus drop off and parking. The replacement facility consists of 13,500sf interior space, 7000sf of covered outdoor decking and 4045lf of Boardwalk constructed of long lasting regional materials that require minimal maintenance. In alignment with its nature based environmental education mission the new Audubon Nature Center is pursuing LEED Certification.

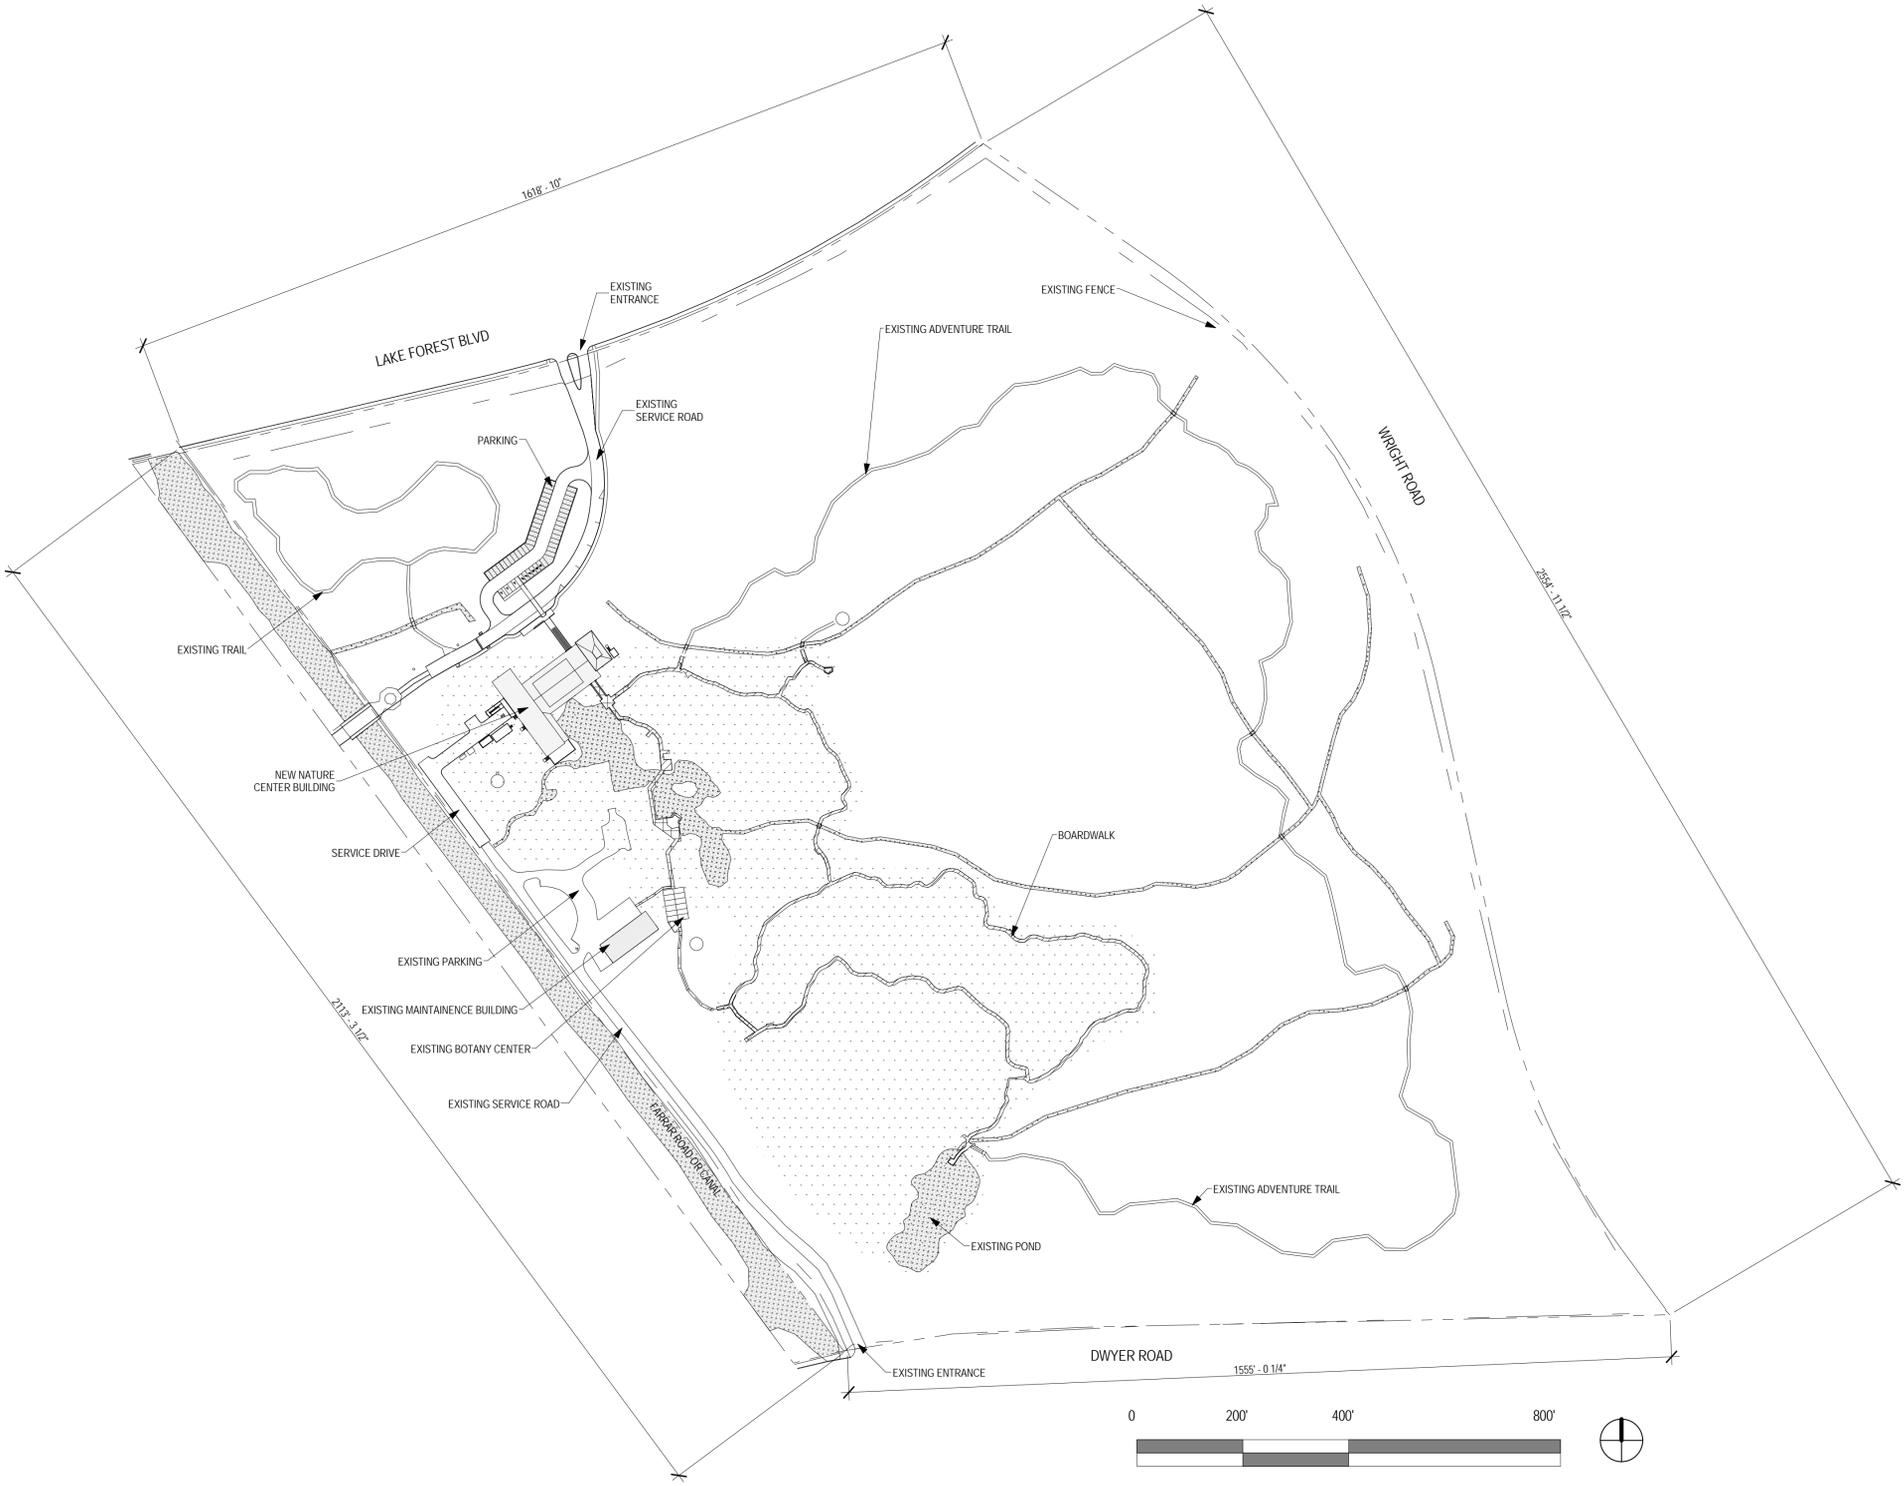

1 Site Plan
 1" = 160'-0"



Existing Boardwalk



Existing Cypress Lagoon



Existing Amphitheatre



Existing Service Drive



Site of Proposed New Construction



Site of Proposed New Construction



Site Entrance at Lake Forest Blvd



Existing Boardwalk



Existing Cypress Lagoon



Existing Buildings to be Demolished



Existing Service Drive



Existing Pond



Existing Maintenance Building



Existing Maintenance Building



Existing Maintenance Building



Existing Maintenance Building



Existing Maintenance Building



Existing Maintenance Building



Existing Botany Center



Existing Botany Center



Existing Botany Center




Existing Botany Center




Existing Botany Center



Existing Botany Center

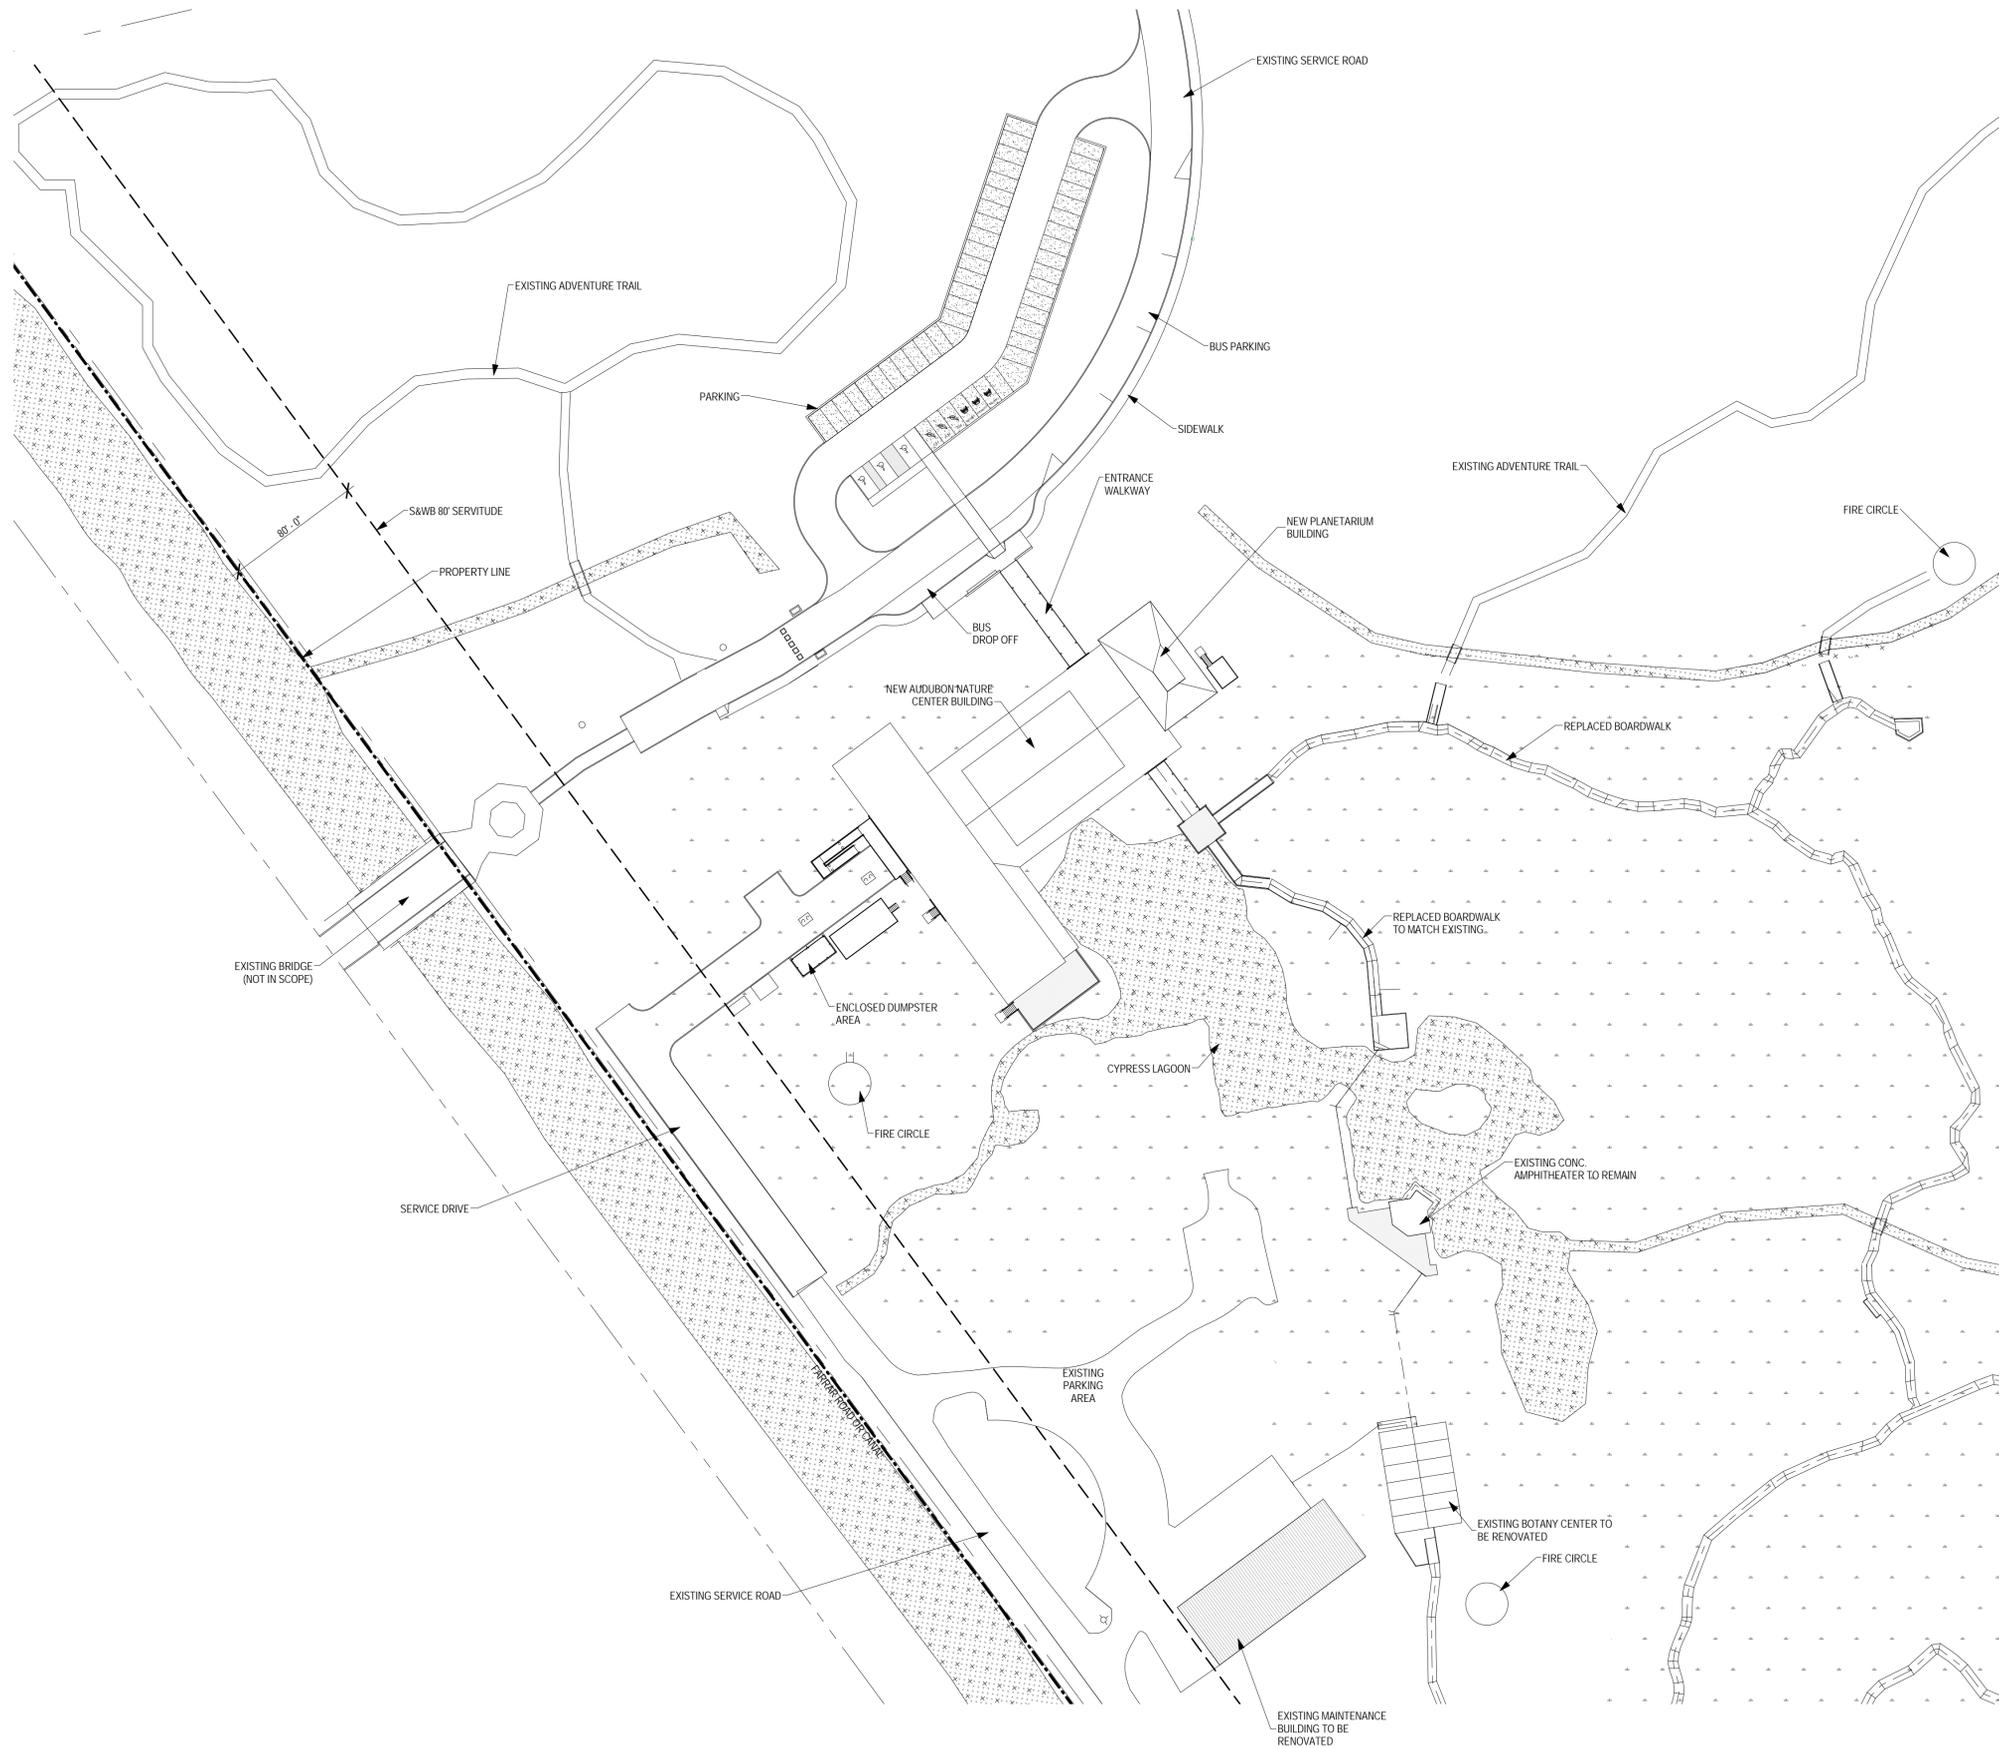




① Enlarged Site Plan
1" = 50'-0"

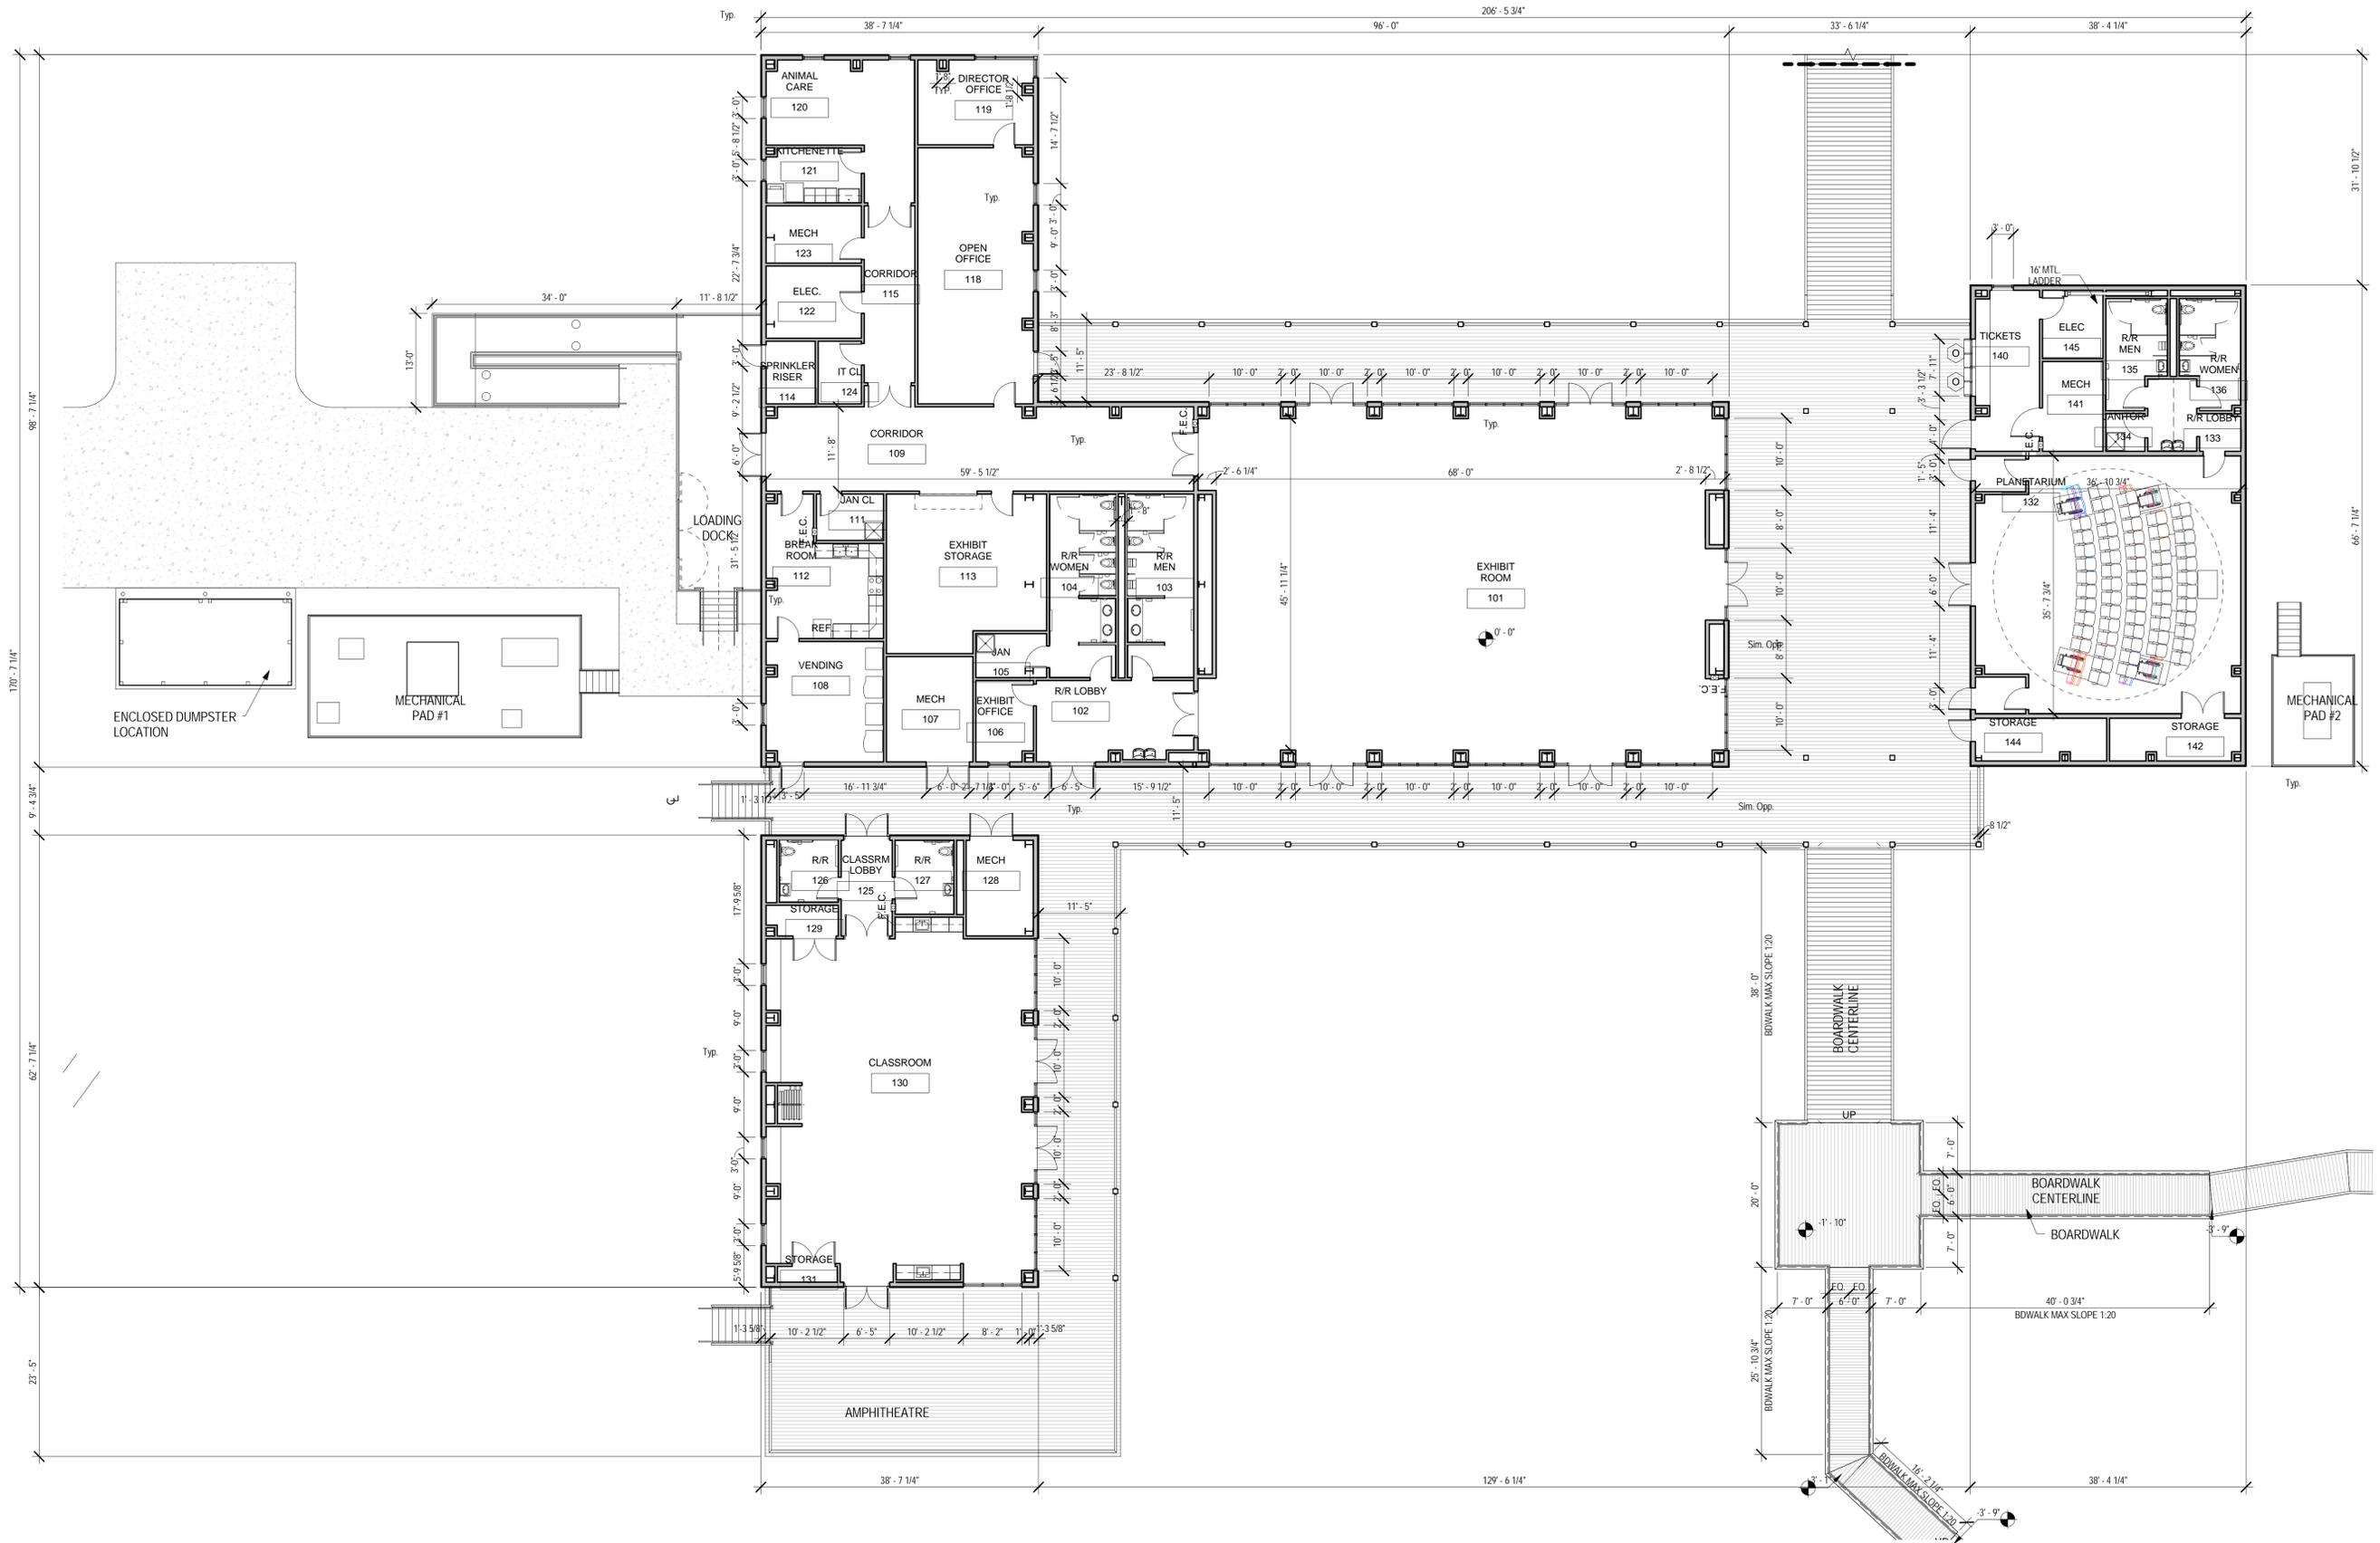


1 FIRST FLOOR PLAN
3/32" = 1'-0"

GENERAL NOTES:


- DO NOT STORE EQUIPMENT OR PARK UNDER DRIP LINE OF EXISTING TREES.
- TREE LOCATIONS TO BE STAKED AND APPROVED BY OWNER PRIOR TO INSTALLATION.
- CONTRACTOR IS RESPONSIBLE FOR REPAIRING AND OR REPLACING ANY DAMAGED AREAS AND REPAIRING ANY RUTS, CAUSED DURING INSTALLATION OF PLANTING MATERIAL.
- LANDSCAPE CONTRACTOR TO COORDINATE WORK WITH OTHER CONTRACTORS ON SITE.
- NO EQUIPMENT ON WALKWAYS. APPROVED MATTING REQUIRED FOR CROSSING OF WALKWAYS.
- QUANTITIES ON LANDSCAPE PLAN ARE MINIMUM ONLY. CONTRACTOR IS RESPONSIBLE FOR HIS OWN QUANTITY TAKE-OFF, AND SHALL PROVIDE ALL PLANT MATERIAL REQUIRED TO FILL PLANT BED AREA AT SPACING ON PLANT SCHEDULE.
- INSTALL WOOD CHIP MULCH WITHIN ALL LANDSCAPE AREAS AT A MINIMUM OF 2" COMPACTED THICKNESS, UNLESS OTHERWISE NOTED. THE MULCH LAYER AROUND NEWLY PLANTED TREES SHALL BE TWO TO THREE TIMES THE DIAMETER OF THE CROWN SPREAD, AT A MINIMUM OF 3" COMPACTED THICKNESS. MULCH ESTABLISHED TREES AT LEAST TO THE DRIP LINE.
- ALL REQUIRED LANDSCAPE AREAS AND BUFFER STRIPS SHALL BE PROVIDED WITH AN IRRIGATION SYSTEM TO ALLOW 100 PERCENT COVERAGE. CONTRACTOR SHALL PROVIDE AN UNDERGROUND PERMANENT IRRIGATION SYSTEM. ALL IRRIGATION LINES SHALL BE INSTALLED SO AS TO NOT IMPACT THE ROOT ZONES OF EXISTING TREES.
- SOD ALL DISTURBED AREAS AND SLOPES GREATER THAN 4:1 UNLESS INDICATED TO CONTAIN SEED & MULCH, SHRUBS, GROUNDCOVER, MULCH OR OTHER MATERIAL.
- CONTRACTOR SHALL COORDINATE DAILY AND/OR ROUTINE SWEEPING SCHEDULE AFTER ANY AND ALL CONSTRUCTION ACTIVITIES THAT CAUSE TRACKING ONTO PUBLIC STREETS.
- FOR LANDSCAPE AREAS HAVING SLOPES GREATER THAN 4:1, INSTALL PINE MULCH AT A MINIMUM OF 2" COMPACTED THICKNESS.
- PERFORM A SOIL TEST AND APPLY THE NECESSARY AMENDMENTS AND/OR FERTILIZER. THE PLANTING AREAS SHALL NOT BE UNSUITABLE COMPACTED BACKFILL, BUT FERTILE WELL-DRAINED LOAMY TOPSOIL WITH AN APPROPRIATE RATIO OF NITROGEN, POTASSIUM, PHOSPHORUS AND MICRO-NUTRIENTS (CORRESPONDING TO THE NEEDS OF A SOIL TEST).

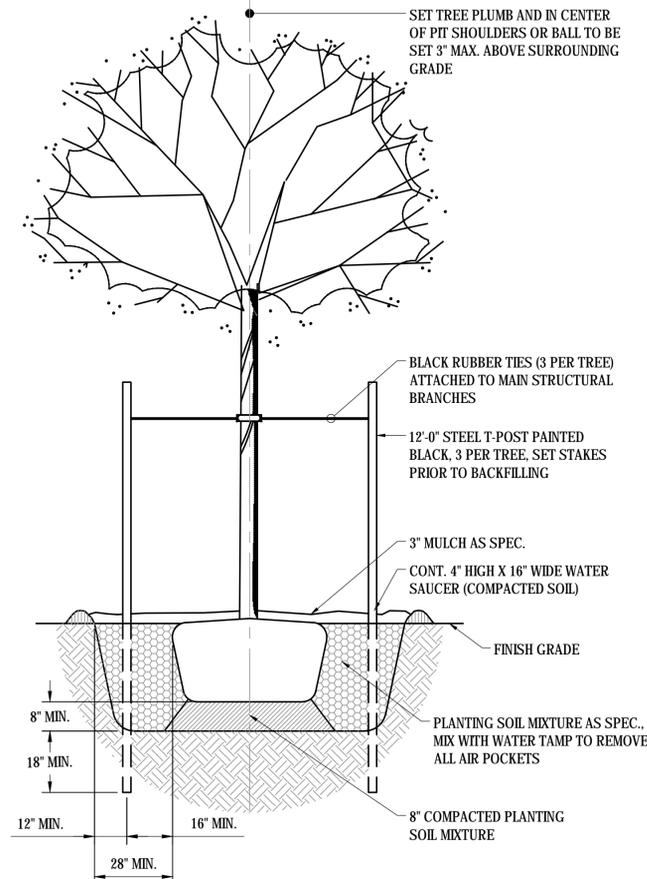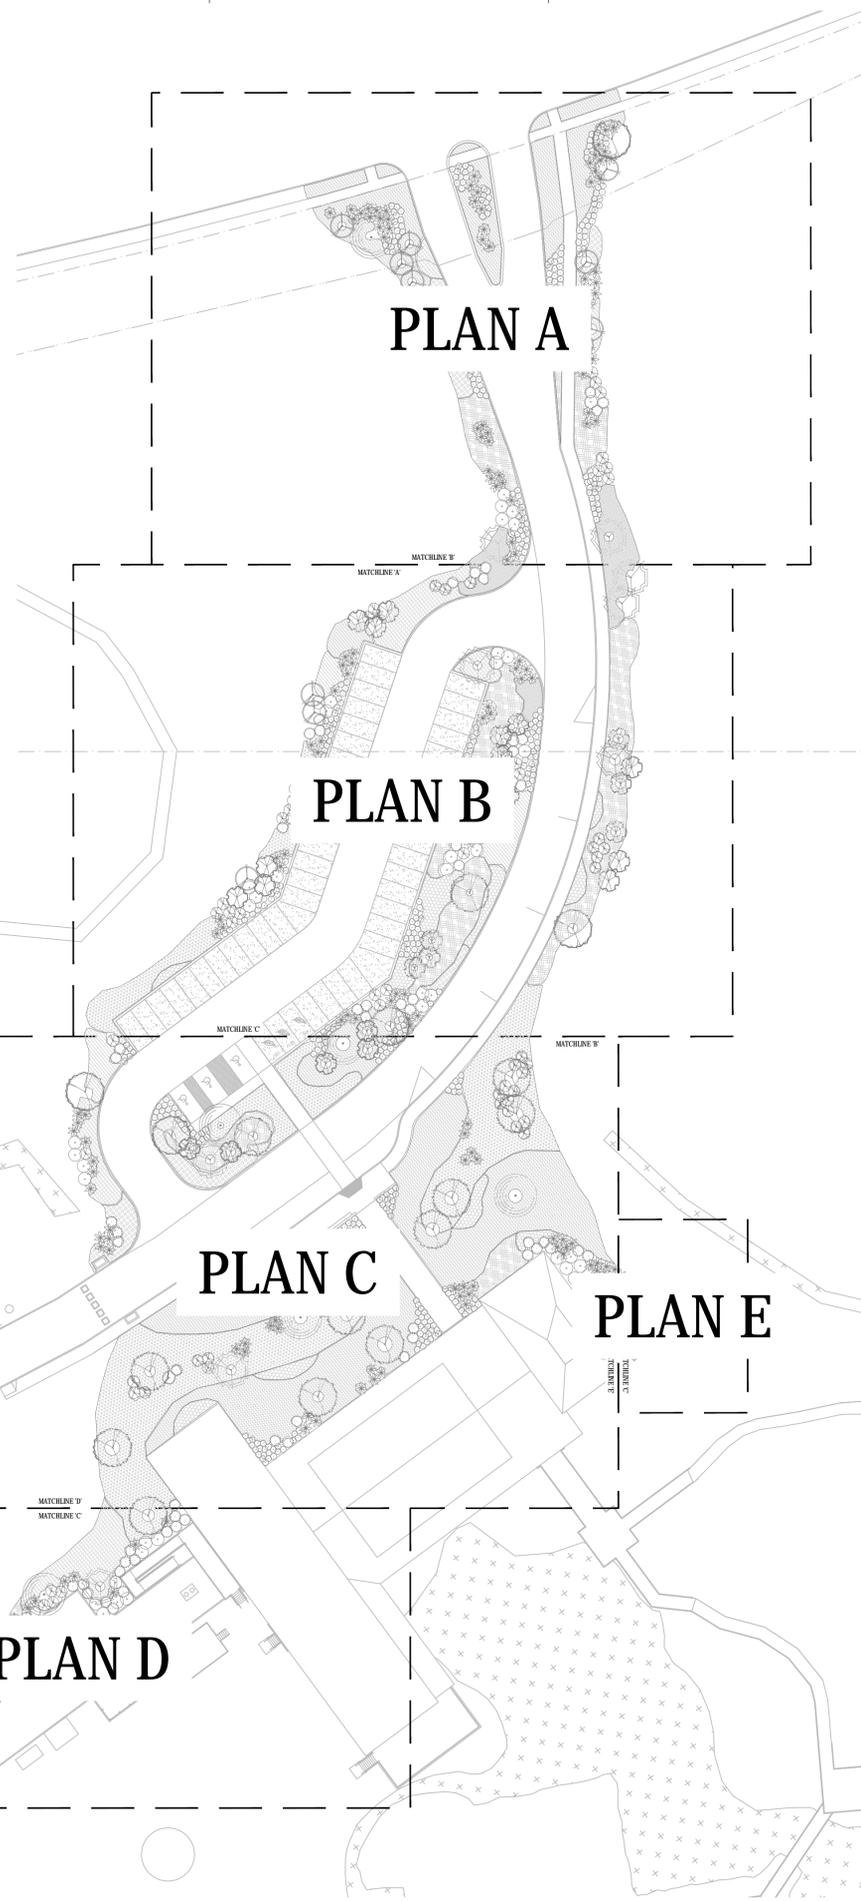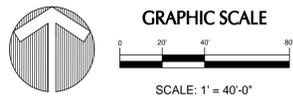


1 TREE PLANTING W/ WATER BAG DETAIL
LA100 SECTION SCALE: NTS

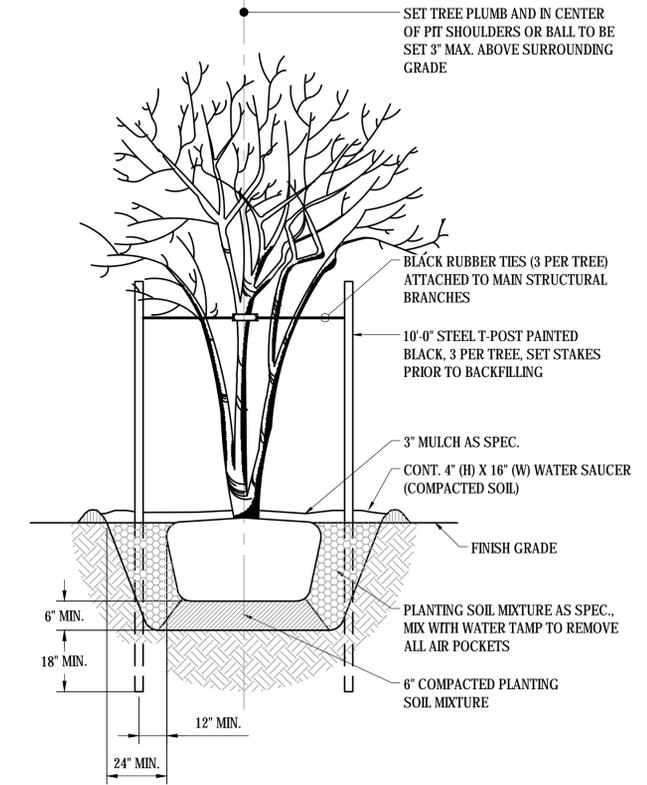


3 MULTI-TRUNK TREE PLANTING DETAIL
LA100 SECTION SCALE: NTS

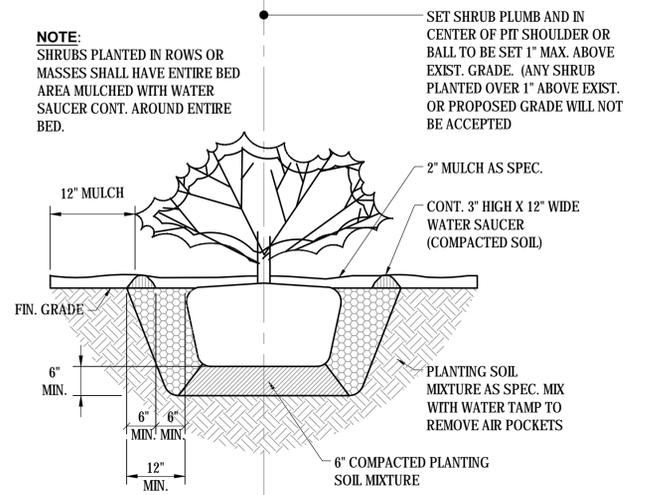

2 SHRUB PLANTING DETAIL
LA100 SECTION SCALE: NTS

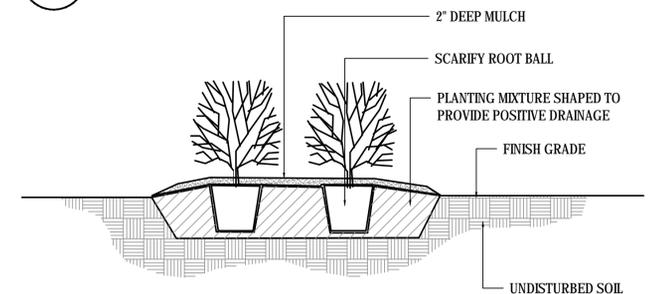

4 MASS SHRUB PLANTING DETAIL
LA100 SECTION SCALE: NTS

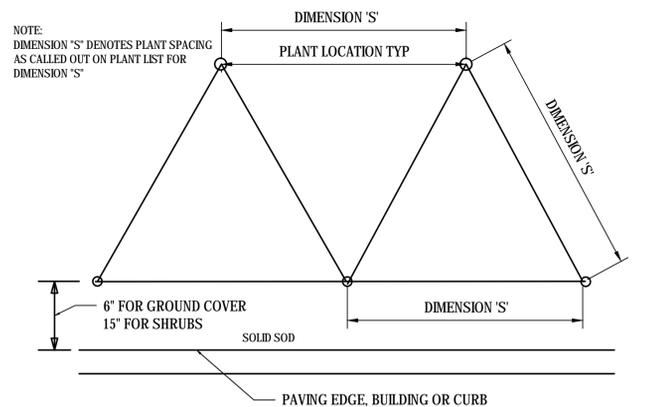

5 TRIANGULAR SPACING
LA100 PLAN SCALE: NTS

Permit and Pricing Set

Audubon Nature Institute
6500 Magazine Street, New Orleans, Louisiana 70118

Audubon Louisiana Nature Center
Landscape Improvement Plan

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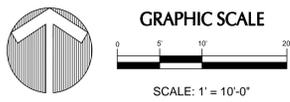
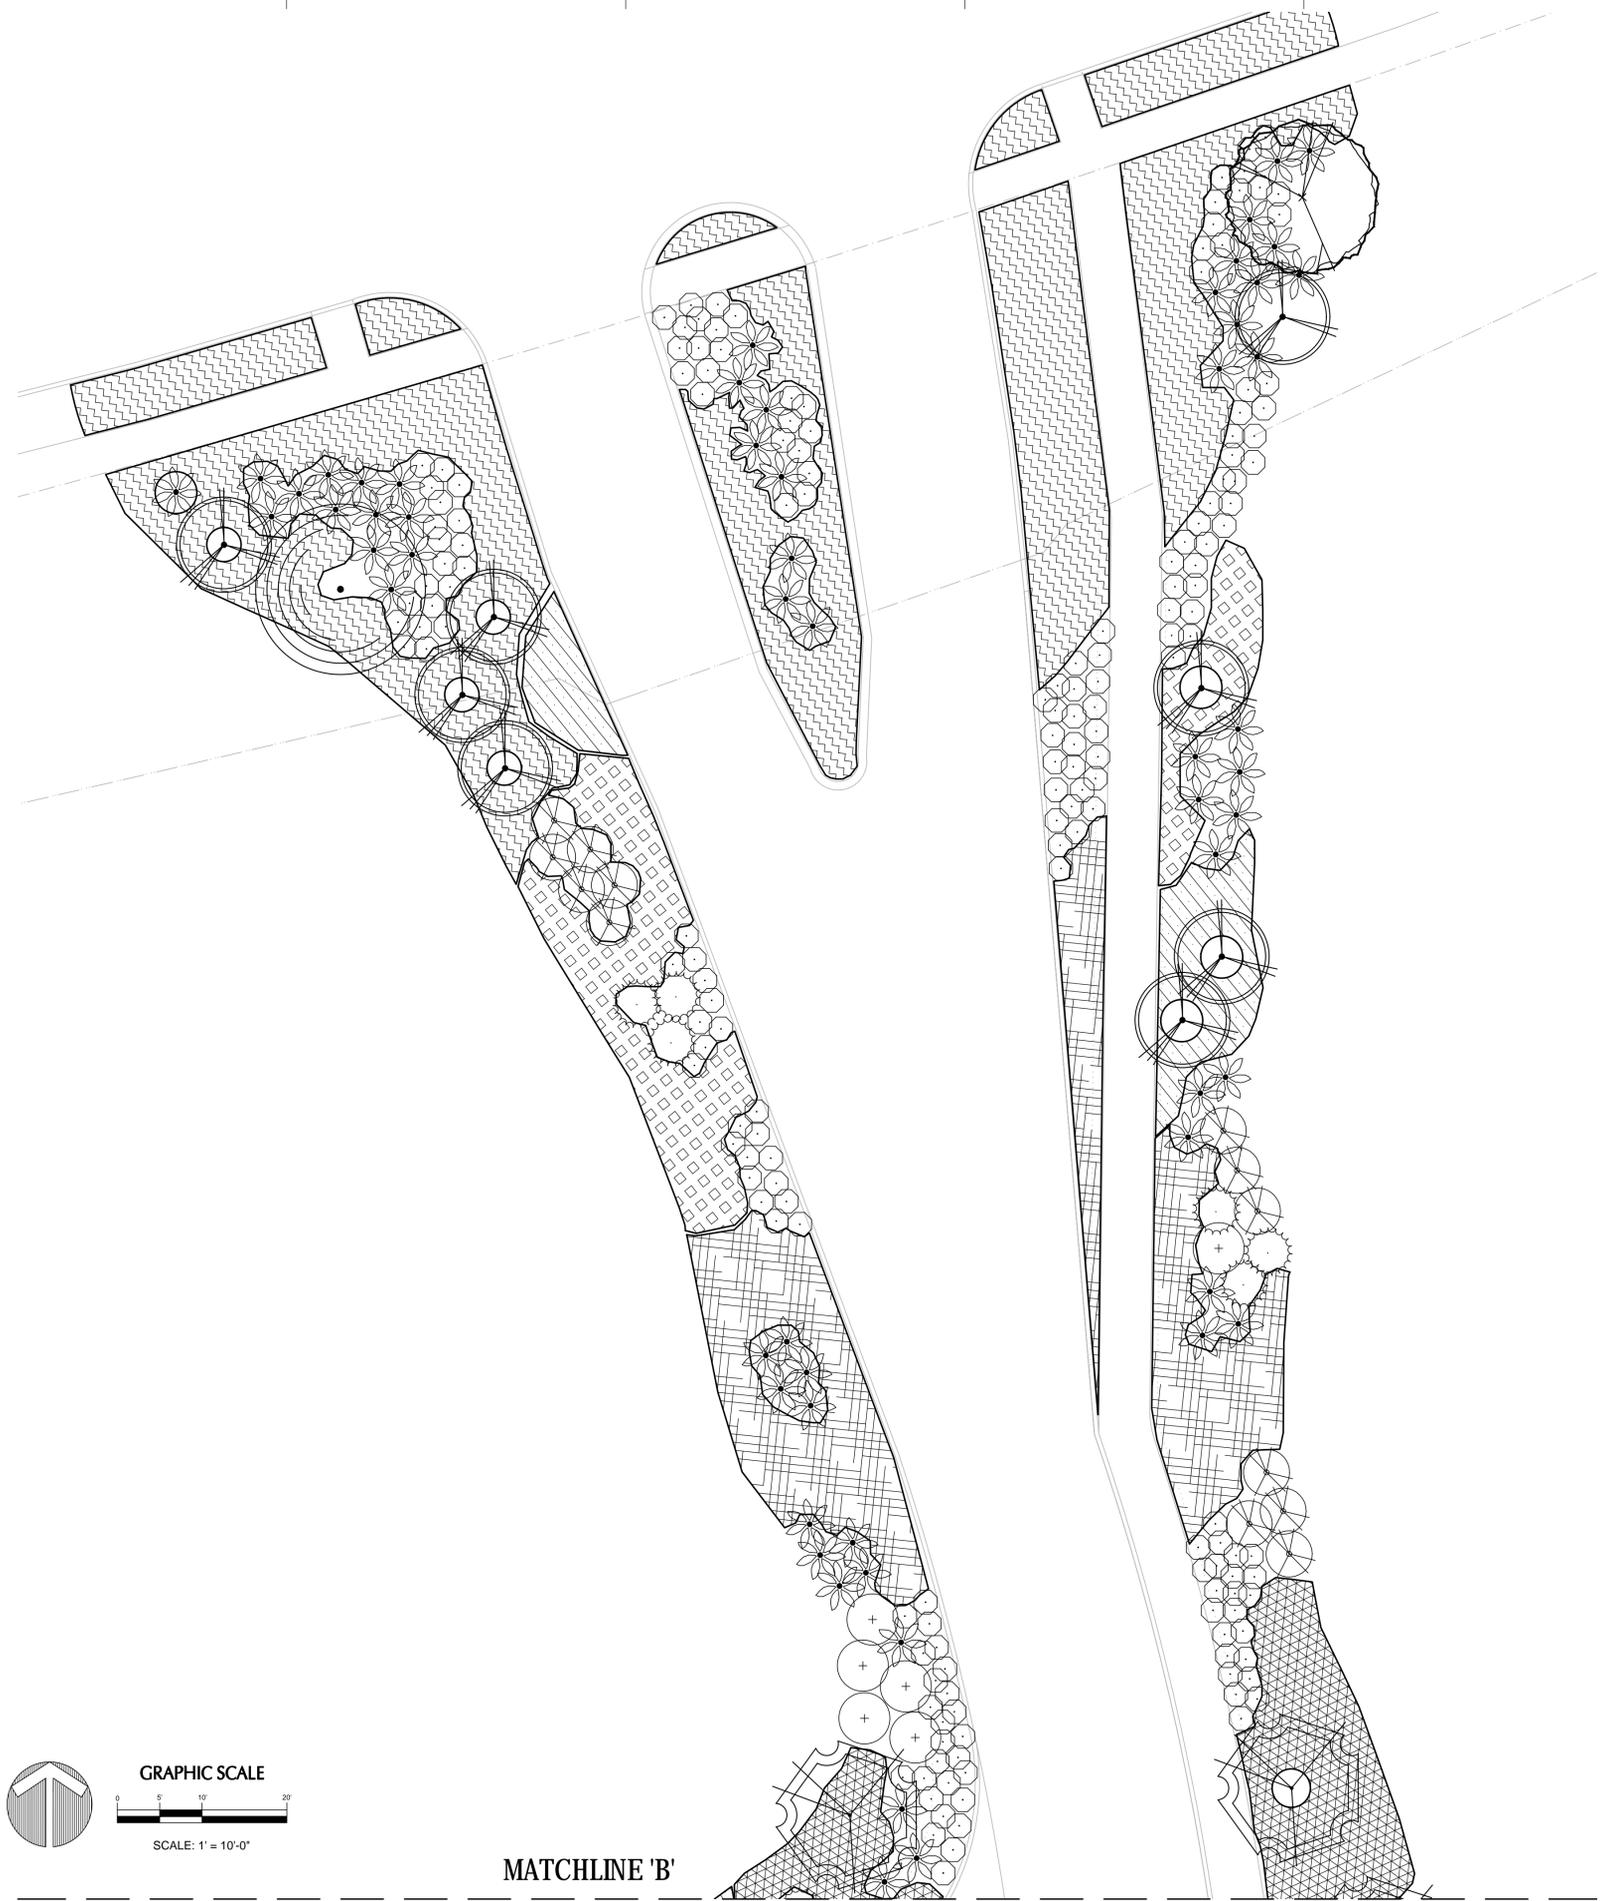


Audubon Louisiana Nature Center

LANDSCAPE PLAN OVERALL

Project No.	.
Date:	07/11/2014
Scale:	.
Drawn By:	KMc
Checked By:	.
Revisions:	.

LA100



MATCHLINE 'B'

Permit and Pricing Set


OWNER: Audubon Nature Institute
 6500 Magazine Street, New Orleans, Louisiana 70118

ARCHITECT:

CONTRACTOR:

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LANDSCAPE PLAN PLAN 'A'

Project No.	.
Date:	07/11/2014
Scale:	.
Drawn By:	KMc
Checked By:	.
Revisions:	.

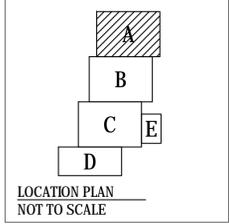LA101



Permit and Pricing Set


Audubon Nature Institute
6500 Magazine Street, New Orleans, Louisiana 70116

OWNER:
ARCHITECT:
CONTRACTOR:

**Audubon Louisiana Nature Center
Landscape Improvement Plan**
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Audubon Louisiana Nature Center





LOCATION PLAN
NOT TO SCALE

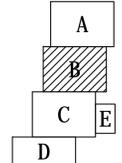**LANDSCAPE PLAN
PLAN 'B'**

Project No.:	.
Date:	07/11/2014
Scale:	.
Drawn By:	KMc
Checked By:	.
Revisions:	.


LA102

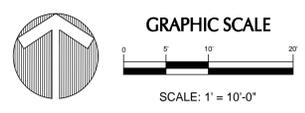

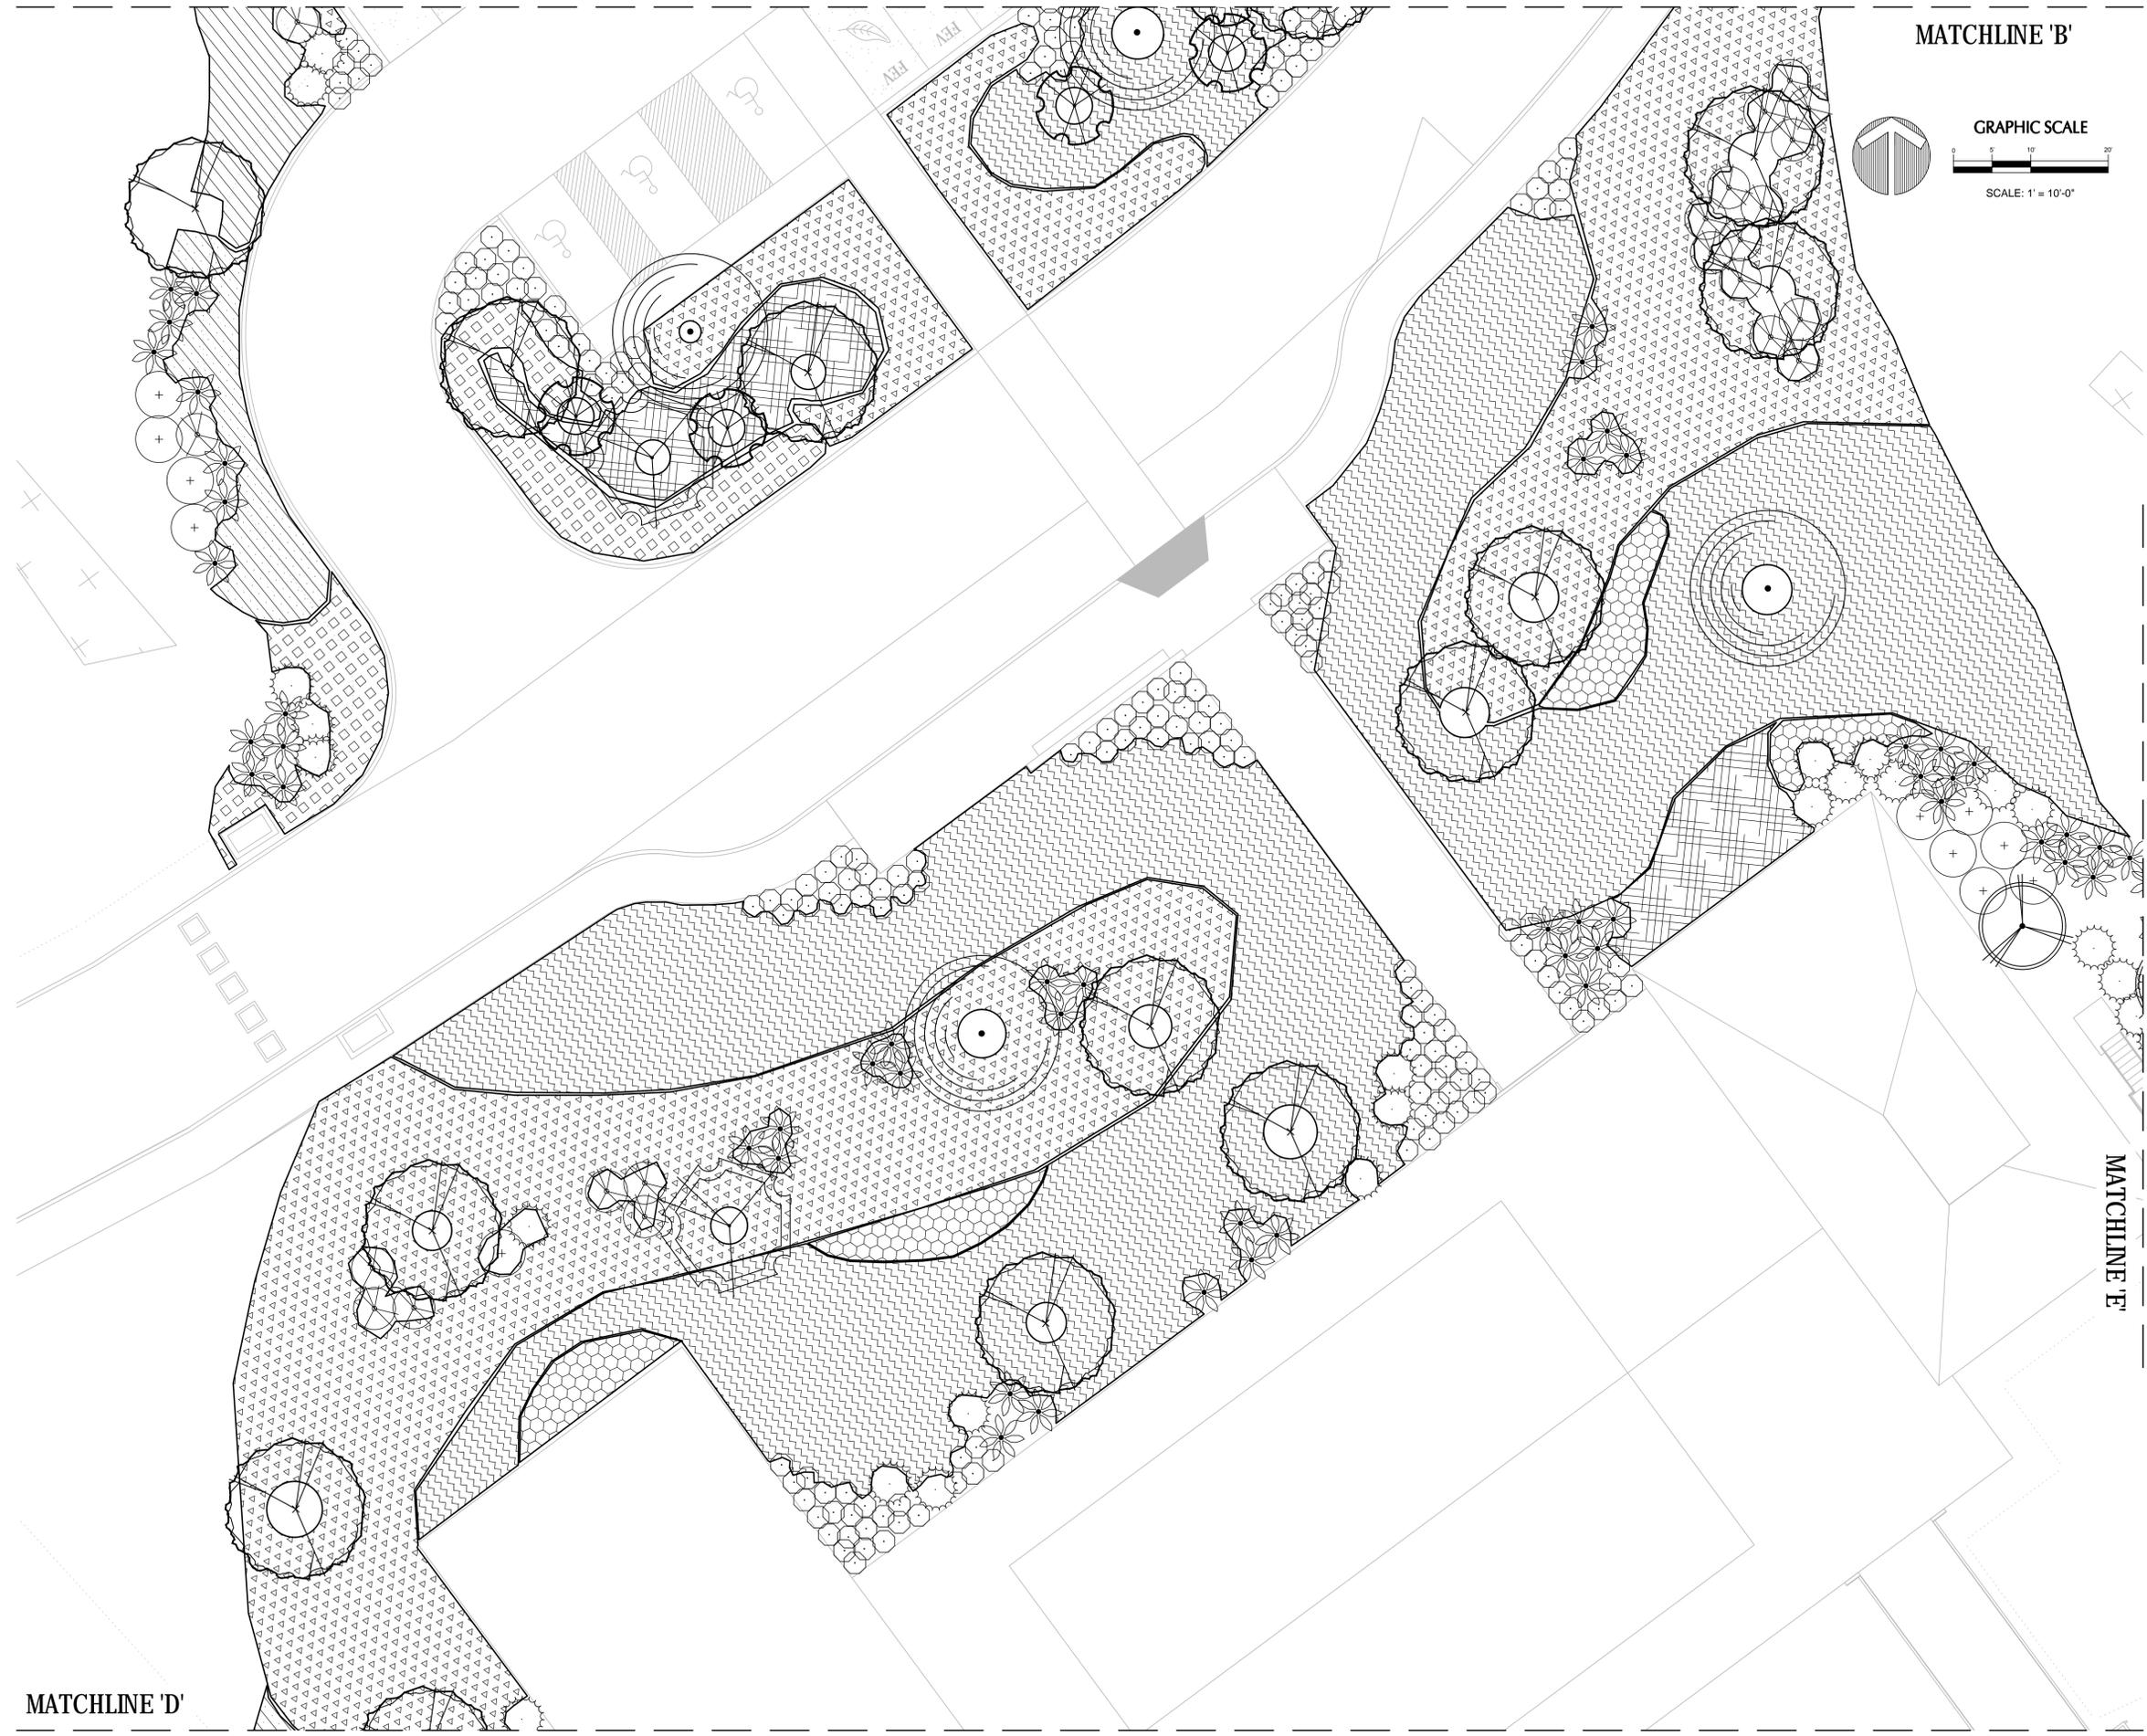

MATCHLINE 'D'

MATCHLINE 'B'

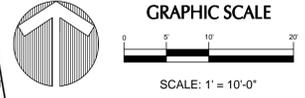

MATCHLINE 'E'

Permit and Pricing Set

OWNER: Audubon Nature Institute
6500 Magazine Street, New Orleans, Louisiana 70116

ARCHITECT:


CONTRACTOR:

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LOCATION PLAN
NOT TO SCALE

LANDSCAPE PLAN PLAN 'C'

Project No.	.
Date:	07/11/2014
Scale:	.
Drawn By:	KMc
Checked By:	.
Revisions:	.

LA103

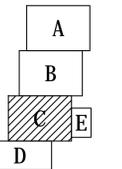OWNER: Audubon Nature Institute
6500 Magazine Street, New Orleans, Louisiana 70118

ARCHITECT:


CONTRACTOR:

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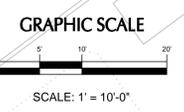
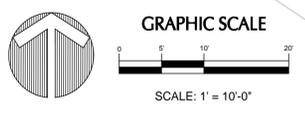
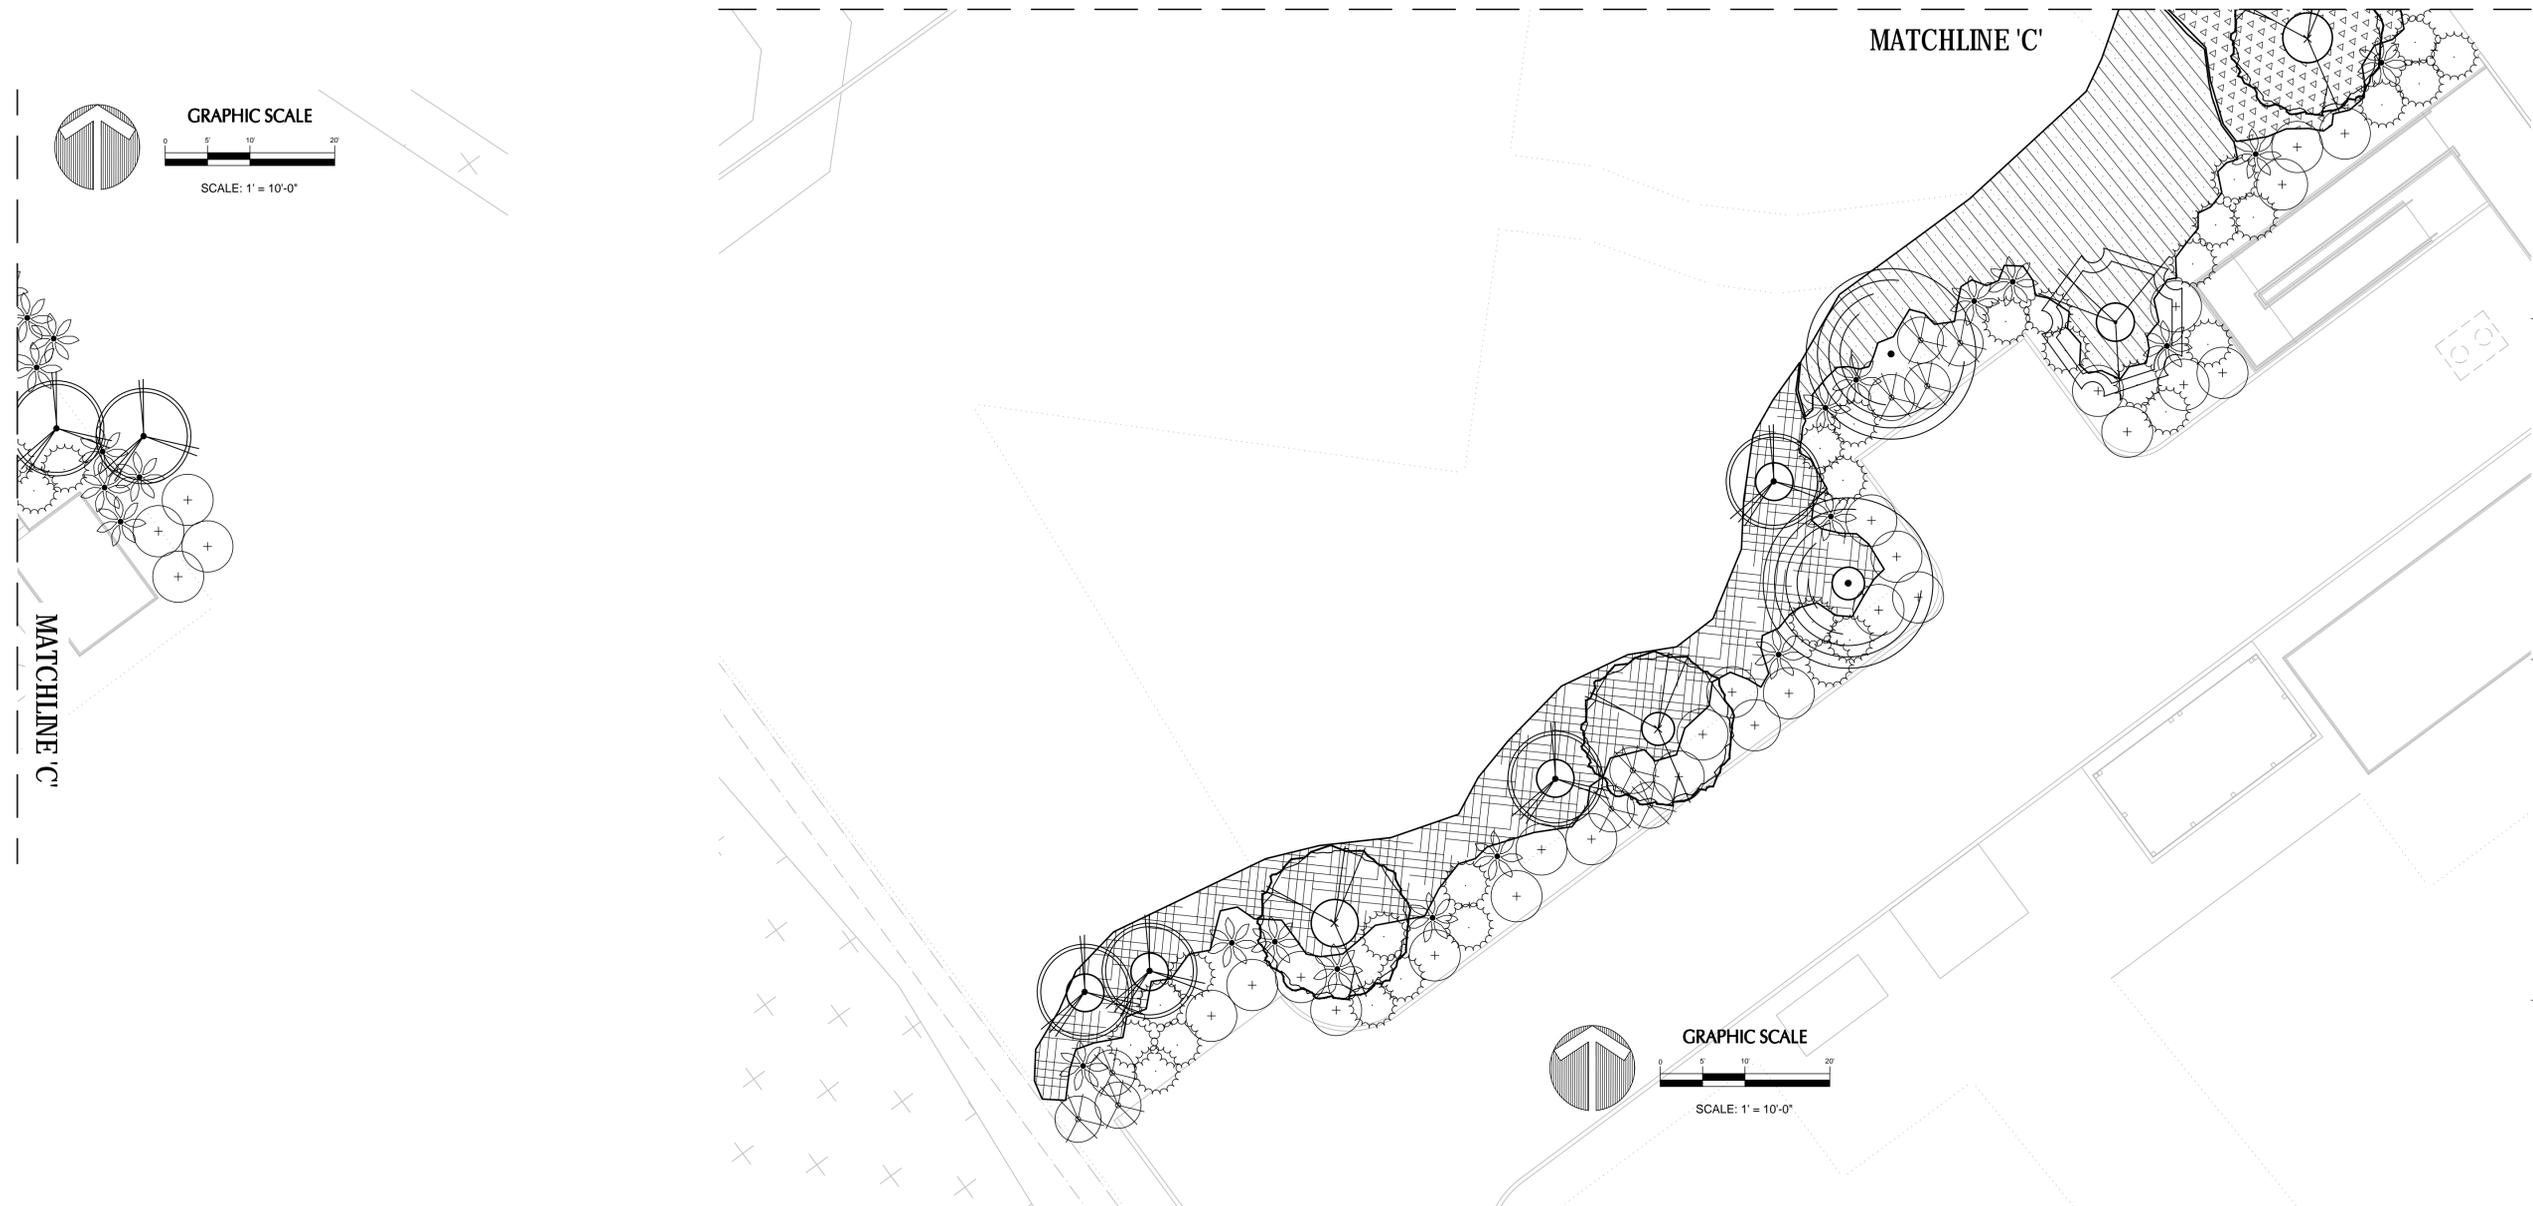


LOCATION PLAN
NOT TO SCALE

LANDSCAPE PLAN PLAN 'D'

Project No.	.
Date:	07/11/2014
Scale:	.
Drawn By:	KMc
Checked By:	.
Revisions:	.

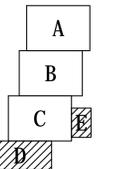LA104



MATCHLINE 'C'

MATCHLINE 'C'

TREE LEGEND

	(AR) DRUMMOND RED MAPLE
	(MV) SWEET BAY MAGNOLIA
	(QP) WILLOW OAK
	(SB) WEEPING WILLOW
	(TD) BALD CYPRESS

SHRUB LEGEND

	(AM) GIANT ELEPHANT EAR
	(FA) SWAMP PRIVET
	(IT) VIRGINIA WILLOW
	(MC) WAX MYRTLE
	(SM) DWARF PALMETTO

GROUNDCOVER LEGEND

	(CS) SWAMP LILY
	(HC) SWAMP HIBISCUS
	(HL) SPIDER LILY
	(IG) LOUISIANA IRIS

GRASSES LEGEND

	(MS) MAIDEN GRASS
	(SB) SPARTINA BAKERI
	(SM) SEASHORE BLUESTEM
	(TL) CATTAIL

PLANTING SCHEDULE

TREES

KEY	QTY	COMMON NAME	BOTANICAL NAME	ROOT	SIZE	REMARKS
AR	25	ACER RUBRUM VAR. DRUMMONDII	DRUMMOND RED MAPLE	CONT	45 GAL	10-12' HT. X 5-6' SPR., 3" CAL.
MV	18	MAGNOLIA VIRGINIANA	SWEET BAY MAGNOLIA	CONT	45 GAL	10-12' HT. X 5-6' SPR., 3" CAL.
QP	9	QUERCUS PHELLOS	WILLOW OAK	CONT	45 GAL	10-12' HT. X 5-6' SPR., 3" CAL.
SB	7	SALIX BABILONICA	WEEPING WILLOW	CONT	45 GAL	10-12' HT. X 5-6' SPR., 3" CAL.
TD	19	TAXODIUM DISTICHUM	BALD CYPRESS	CONT	100 GAL	12' HT. X 6-8' SPR., 4" CAL.

SHRUBS

KEY	QTY	COMMON NAME	BOTANICAL NAME	ROOT	SIZE	REMARKS
AM	516	ALOCASIA MACRORHIZA 'MAKI'	GIANT ELEPHANT EAR	CONT	3 GAL.	30" O.C., 24" HT& SPRD.
FA	67	FORESTIERA ACUMINATA	SWAMP PRIVET	CONT	3 GAL.	18" X 24", 3' O.C.
IV	73	ITEA VIRGINICA	VIRGINIA WILLOW	CONT	3 GAL.	18" X 24", 3' O.C.
MC	84	MYRICA CERIFERA	WAX MYRTLE	CONT	3 GAL.	18" X 24", 3' O.C.
SM	171	SABOL MINOR	DWARF PALMETTO	CONT	3 GAL.	18" X 24", 3' O.C.

GROUNDCOVER

KEY	QTY	COMMON NAME	BOTANICAL NAME	ROOT	SIZE	REMARKS
CS	245	CRINUM AMERICANUM	SWAMP LILY	CONT	1 GAL.	FULL, 24" O.C., 18" SPRD.
HC	358	HIBISCUS COCCINEUS	SWAMP HIBISCUS	CONT	1 GAL.	FULL, 24" O.C.
HL	3,325	HYMENOCALLIS LIRIOSME	SPIDER LILY	CONT	3 GAL.	FULL, 24" O.C., 18" SPRD.
IG	3,090	IRIS GIGANTICAERULEA	LOUISIANA IRIS	CONT	1 GAL.	FULL, 18" O.C.

GRASSES

KEY	QTY	COMMON NAME	BOTANICAL NAME	ROOT	SIZE	REMARKS
MS	632	MISCANTHUS SINENSIS 'PURPURASCENS'	MAIDEN GRASS	CONT	3 GAL.	18" X 15", 3 GAL., 3' O.C.
SE	378	SPARTINA BAKERI	SWITCHGRASS	CONT	3 GAL.,	18" X 15", 3 GAL., 3' O.C.
SMA	566	SCHIZACHYRIUM MARITIMUM	SEASHORE BLUESTEM	CONT	1 GAL.	FULL; 18" O.C.; SAND; FERTILIZE WHEN PLANTING; WARM-SEASONED PERENNIAL
TL	4,126	TYPHA LATIFOLIA	CATTAIL	CONT	1 GAL.	FULL, 18" O.C.

Permit and Pricing Set

Audubon Nature Institute
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OWNER

ARCHITECT


CONTRACTOR

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Audubon Louisiana Nature Center



LOCATION PLAN
NOT TO SCALE


LANDSCAPE PLAN
PLAN 'D'

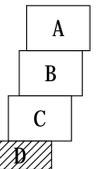Project No. .
Date: 07/11/2014
Scale: .
Drawn By: KMc


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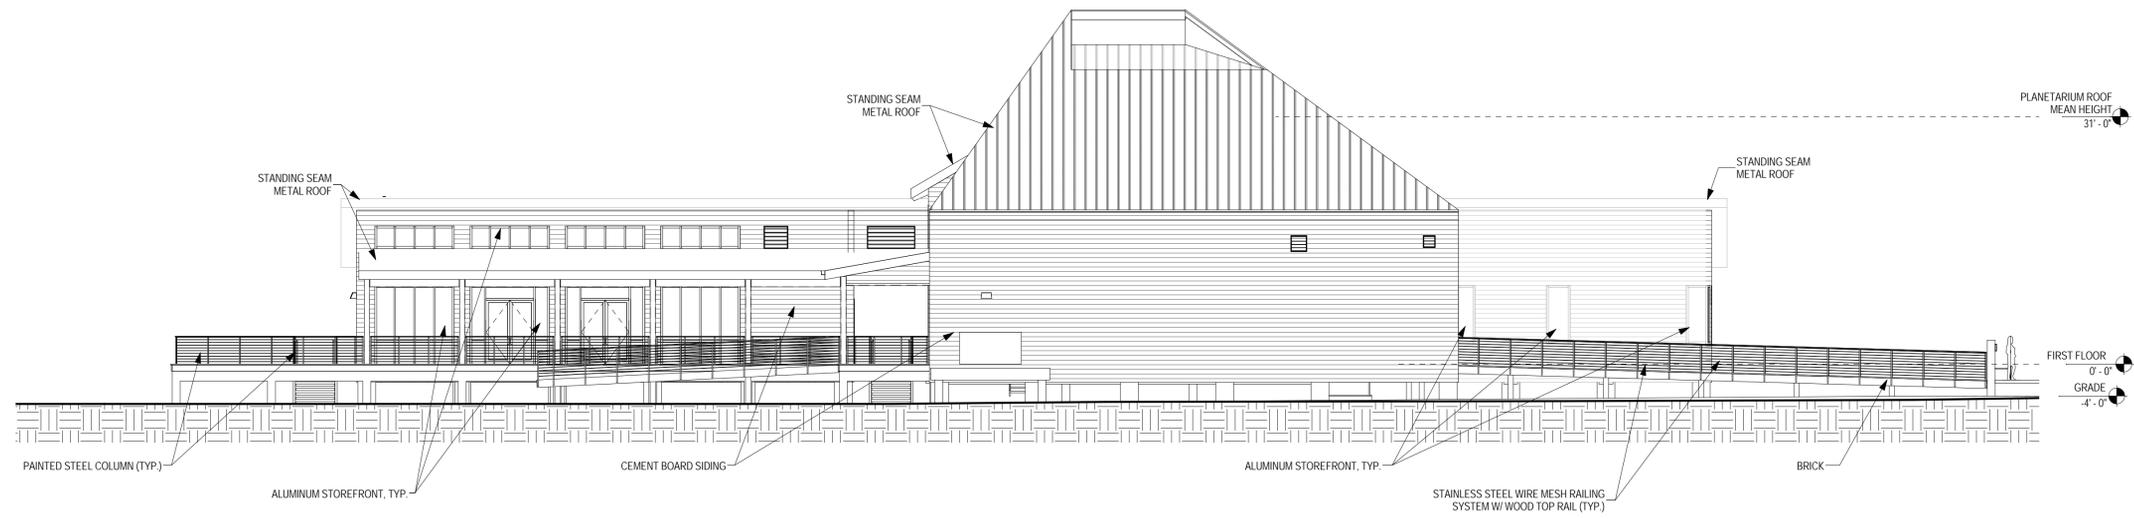
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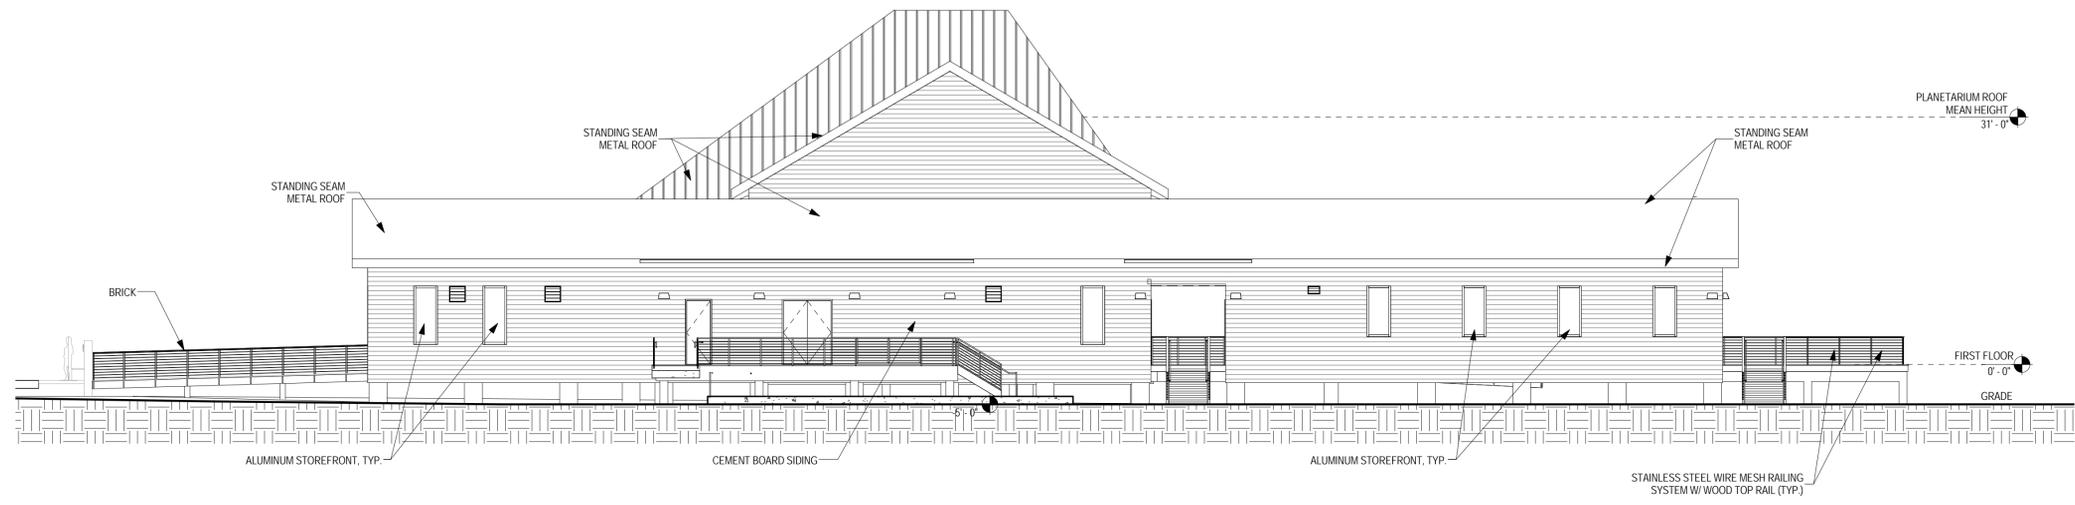
1 North Elevation
3/32" = 1'-0"



2 South Elevation
3/32" = 1'-0"

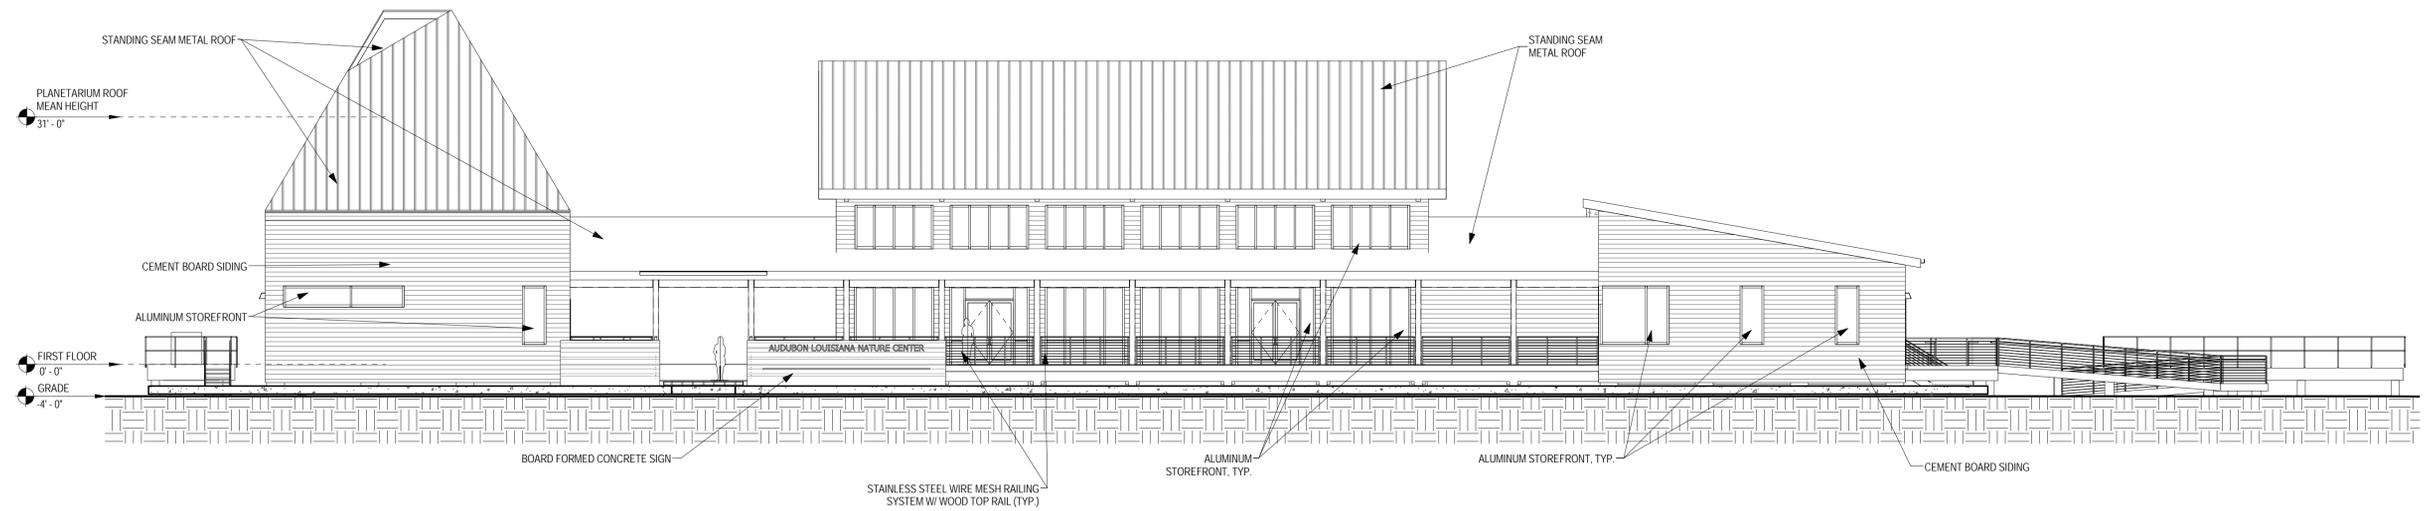

① East Elevation
3/32" = 1'-0"

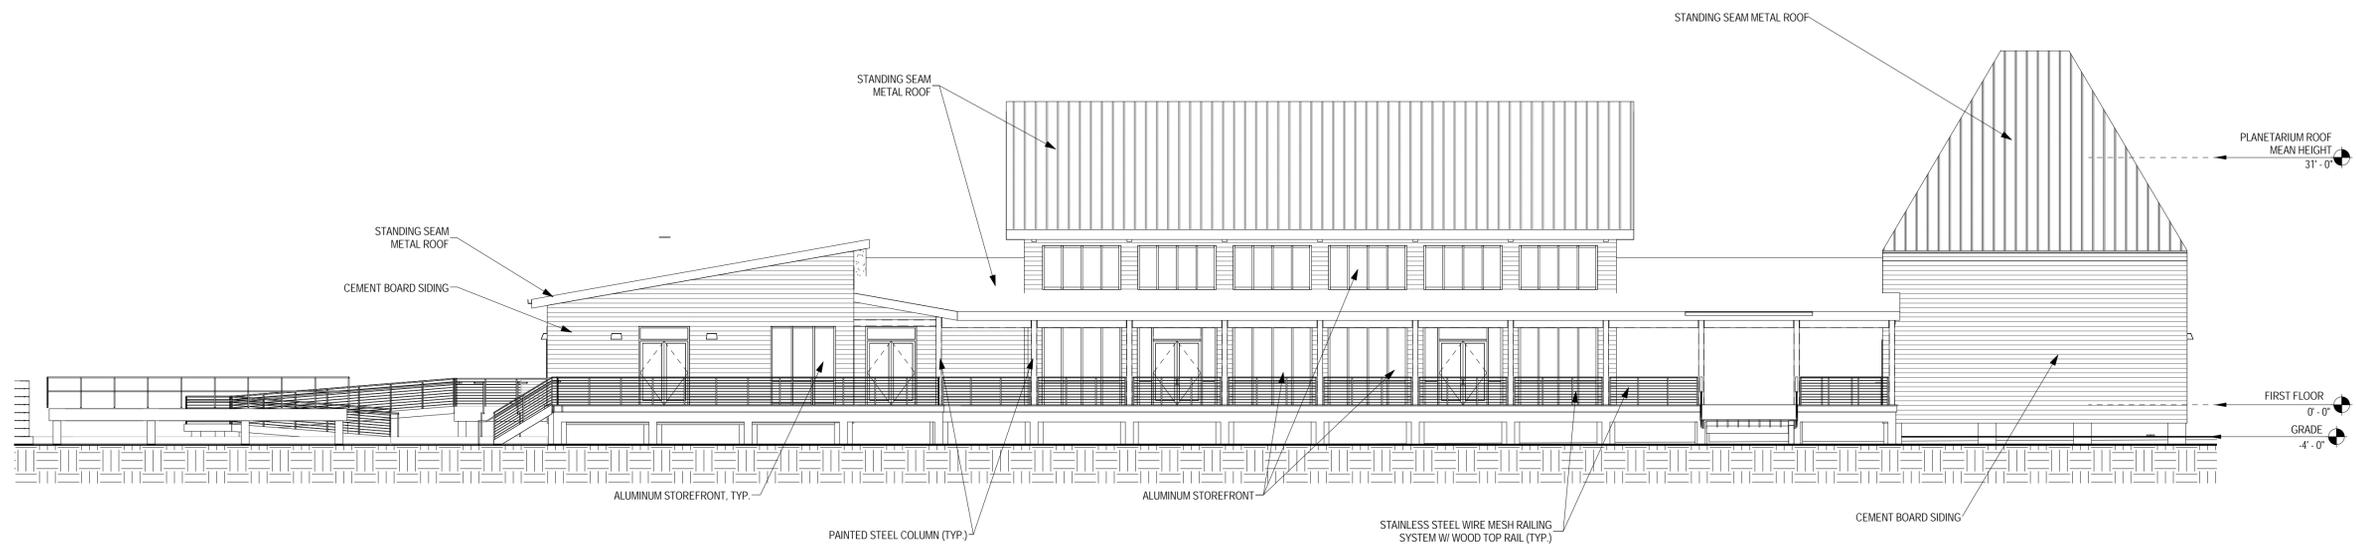

② West Elevation
3/32" = 1'-0"



View of Main Entrance



View of Exterior Covered Walkway overlooking the Cypress Lagoon



Metal Roof



Glass



Precedent Image




Painted Metal



Painted Wood Siding



Wood Floor/Ceiling

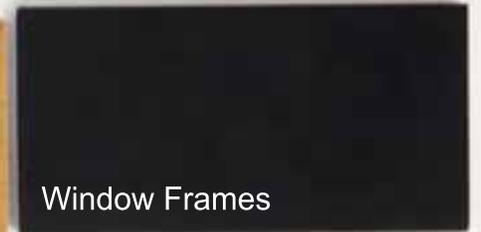

Window Frames

- GENERAL DEMOLITION NOTES:**
- ONLY REMOVE SPECIFIC COMPONENTS OF THE BOTANY CENTER AS OUTLINED BELOW.
 - ALL COMPONENTS NOT BEING REMOVED SHALL BE CLEANED, PAINTED, AND PROTECTED.
 - REMOVE ALUMINUM DOWNSPOUTS
 - REMOVE SUBMERSIBLE PUMP AND ALL ASSOCIATED CONDUIT AND WIRING.

- DEMOLITION KEY NOTES:**
1. REMOVE LATTICE WORK AND ASSOCIATED WOOD FRAMING.
 2. EXISTING CMU PLANTERS TO REMAIN.
 3. SAWCUT A 16-1/4" x 8-1/4" OPENING IN CONCRETE WALL FOR NEW DUAL FUNCTION FLOOD + VENTILATION VENT. SEE DETAIL 6/A2.00.
 4. REMOVE EXISTING SPACE HEATER AND ALL ASSOCIATED CONDUIT WIRING.
 5. REMOVE GLAZING, GLAZING PUTTY, AND MECHANICALLY CLEAN GLASS SEATS (TYP)
 6. REMOVE EXISTING ELECTRICAL LOAD CENTER LIGHTING, WIRING, AND CONDUIT.
 7. REMOVE EXISTING WOOD PLANTER
 8. REMOVE (2) VENTILATION FANS INCLUDING ASSOCIATED CONDUIT WIRING AND LOUVERS.
 9. REMOVE ALL LIGHT FIXTURES AND ALL ASSOCIATED CONDUIT AND WIRING.
 10. REMOVE ALL ELECTRICAL OUTLETS, OUTLET BOXES, SWITCHES, SWITCH PLATES, AND ALL ASSOCIATED CONDUIT AND WIRING.
 11. REMOVE (6) COMPACT BRASS FAUCETS.



LATTICE FRAMING



CABLE LIGHTING



EXHAUST FRAMES AND LATTICE WORK



OPERATING WINDOWS



ELECTRICAL LOAD CENTER AND EXHAUST FAN



SPACE HEATER




PLANTERS




PLANTER AND LATTICE WORK




PLANTER

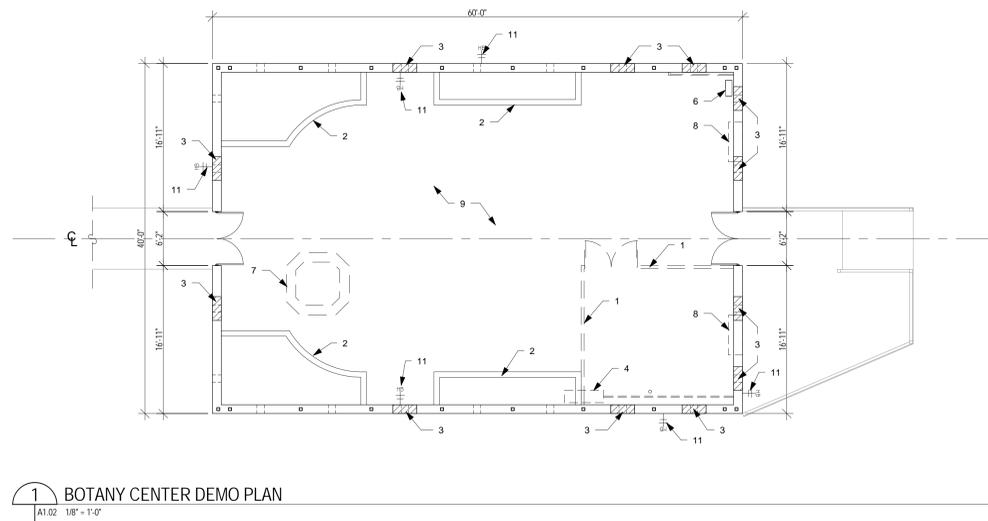


1 BOTANY CENTER DEMO PLAN
A1.02 1/8" = 1'-0"

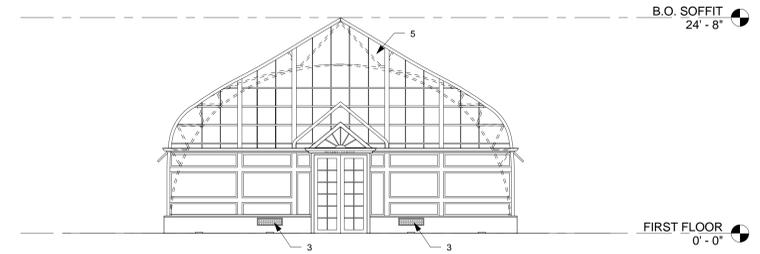


2 BOTANY CENTER DEMO NORTH ELEVATION
A1.02 1/8" = 1'-0"

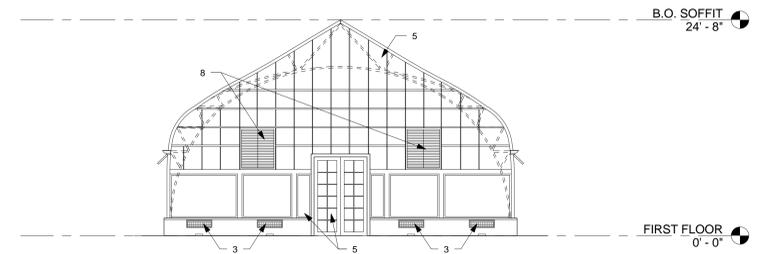

3 BOTANY CENTER DEMO SOUTH ELEVATION
A1.02 1/8" = 1'-0"

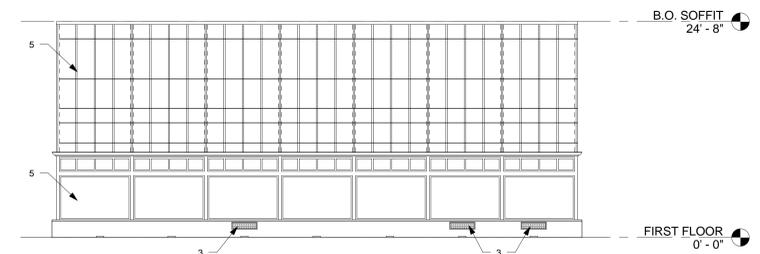

4 BOTANY CENTER DEMO WEST ELEVATION
A1.02 1/8" = 1'-0"

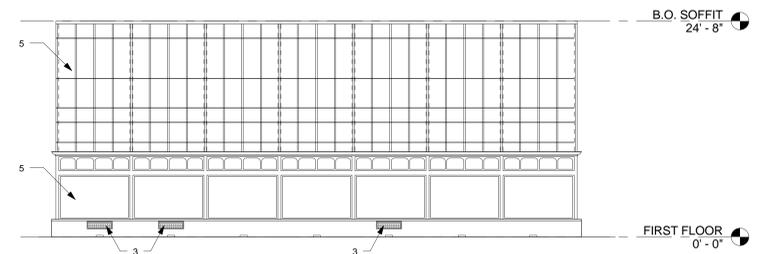

5 BOTANY CENTER DEMO EAST ELEVATION
A1.02 1/8" = 1'-0"

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These drawings and specifications have been prepared under the close personal supervision and to the best of my knowledge the company with all local and state requirements. I WILL NOT be observing the work.


PROJECT NO.	LA 10.0242.90
DRAWN BY:	Author
CHECKED BY:	Checker
DATE	PHASE
06/24/2014	CONSTRUCTION DOCS.

GENERAL NOTES:


- FURNISH AND INSTALL NEW 1/4" THICK LAMINATED CLEAR GLAZING COMPONENTS TO MATCH EXISTING IN SURFACE TREATMENT AND FINISH. INSERT GLAZING INTO OPEN ROOF, WALL AND WINDOW FRAMES AND SET IN GLAZING COMPOUND.
- MECHANICALLY CLEAN, PRIME, AND PAINT ALL STEEL FRAMING.
- REPAIR, PAINT, AND LUBRICATE WINDOW OPERATING SYSTEM.
- REPAIR OR REPLACE FINISH HARDWARE INCLUDING LOCKSET, BUTTS, AND ADD CLOSER WITH COVER, BRONZE THRESHOLD, AND WEATHERSTRIPPING. REPLACE DOOR ASTRAGALS, PRIME, AND PAINT.

KEY NOTES:


- EXISTING OPENINGS TO REMAIN. CLEAR OBSTRUCTIONS.
- DUAL FUNCTION FLOOD AND VENTILATION VENT. SEE DETAIL 6/A2.00
- REFINISH DOOR AND REPLACE GLAZING AND HARDWARE (LOCKSET, BUTTS, FLUSH BOLTS, CLOSURES, AND THRESHOLDS). REVERSE DOOR SWING.
- NEW EXHAUST FANS + LOUVERS.
- PRESSURE WASH CONCRETE FLOOR AND KNEE WALL.
- EXISTING BOARDWALK (N.I.C.)
- REPAIR EXISTING CONCRETE PERIMETER WALL WITH GROUT AND CEMENT AS REQUIRED AT ANY DAMAGED AREAS; CLEAN, PRIME & PAINT (TYP.).
- WELD ALL BROKEN STEEL CONNECTIONS AND PAINT (TYP.).
- MECHANICALLY CLEAN, PRIME, AND PAINT STEEL STRUCTURE.
- REPAIR, CLEAN, PRIME & PAINT WINDOW MECHANISMS. REPLACE AS REQUIRED.
- REPLACE ALL GLAZING, MECHANICALLY CLEAN, PRIME & PAINT WOOD FRAMING.
- MECHANICALLY CLEAN, PRIME & PAINT WOOD TRIM (TYP.).
- REPAIR, CLEAN, PRIME & PAINT EXISTING CMU PLANTERS (TYP.).

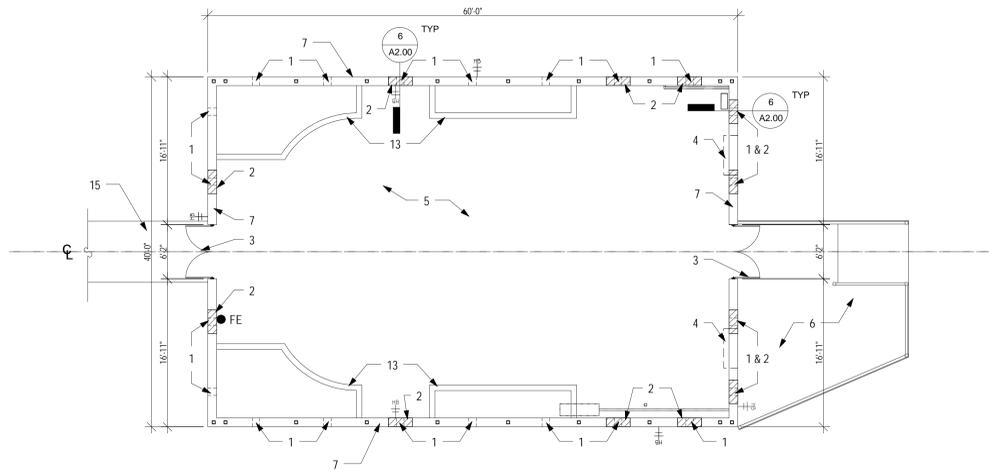


1 BOTANY CENTER FLOOR PLAN
AZ.00 1/8" = 1'-0"

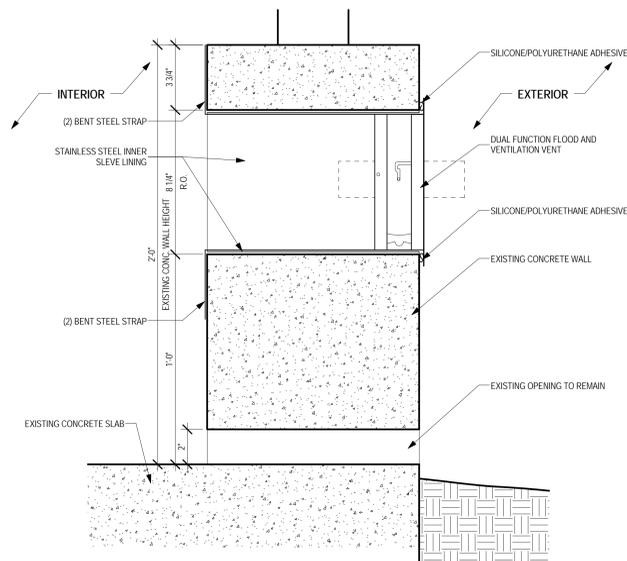


6 FLOOD VENT DETAIL
AZ.00 3" = 1'-0"

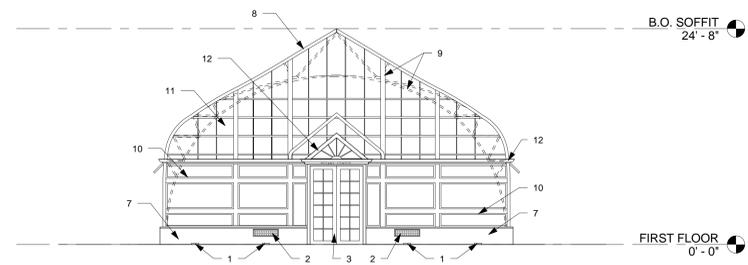


2 BOTANY CENTER NORTH ELEVATION
AZ.00 1/8" = 1'-0"

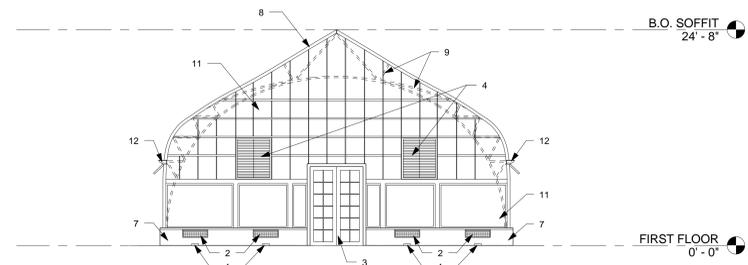

3 BOTANY CENTER SOUTH ELEVATION
AZ.00 1/8" = 1'-0"

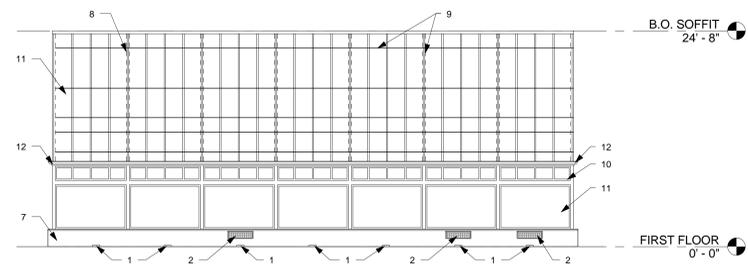

4 BOTANY CENTER WEST ELEVATION
AZ.00 1/8" = 1'-0"

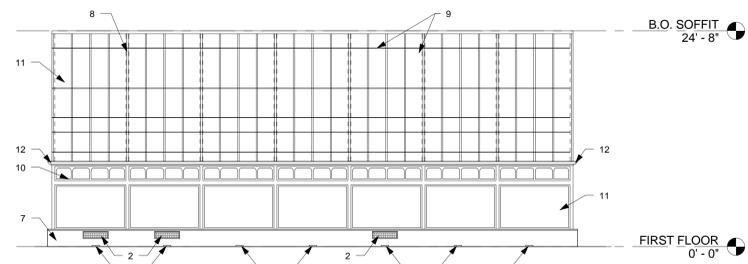

5 BOTANY CENTER EAST ELEVATION
AZ.00 1/8" = 1'-0"

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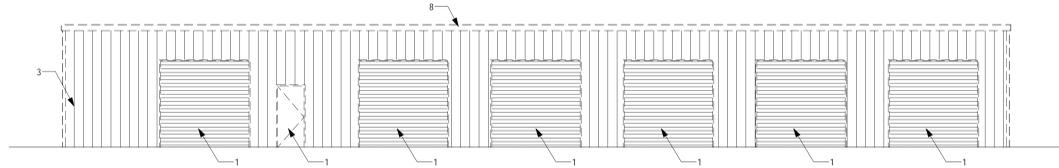
PROJECT NO.	LA 10.0242.90
DRAWN BY:	Author
CHECKED BY:	Checker
DATE	PHASE
06/24/2014	CONSTRUCTION DOCS.

GENERAL DEMOLITION NOTES:


- ONLY REMOVE SPECIFIC COMPONENTS OF THE MAINTENANCE BUILDING AS OUTLINED BELOW.
- ALL COMPONENTS NOT BEING REMOVED SHALL BE CLEANED, PAINTED, AND PROTECTED.
- RETAIN EXISTING CONCRETE SLAB, STEEL COLUMNS, AND STEEL BEAMS UNLESS OTHERWISE NOTED.

DEMOLITION KEY NOTES:


1. REMOVE EXISTING DOOR AND TRACK, REMOVE STEEL HEADER AND FRAMING.
2. REMOVE METAL DOWNSPOUTS AND GUTTERS.
3. REMOVE METAL SIDING AND ASSOCIATED METAL TRIM.
4. REMOVE WOOD STUD WALL, PLYWOOD SHEATHING, AND ASSOCIATED COMPONENTS.
5. REMOVE WOOD SHELVING AND ASSOCIATED COMPONENTS.
6. REMOVE SERVICE SINK, PLUMBING, AND ALL ASSOCIATED COMPONENTS.
7. REMOVE ALL ELECTRICAL OUTLETS, OUTLET BOXES, SWITCHES, SWITCH PLATES, AND ALL ASSOCIATED CONDUIT AND WIRING.
8. REMOVE METAL ROOF, INSULATION, AND ASSOCIATED COMPONENTS.
9. REMOVE LATTICE SCREEN AND ASSOCIATED COMPONENTS.




2 MAINTENANCE BLDG. DEMO NORTH ELEVATION
A1.02 1/8" = 1'-0"

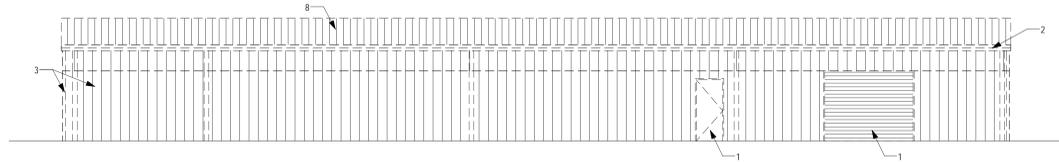


3 MAINTENANCE BLDG. DEMO SOUTH ELEVATION
A1.02 1/8" = 1'-0"

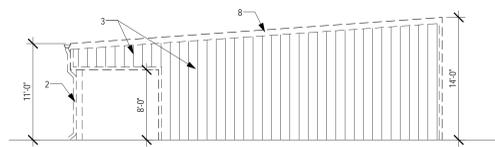

4 MAINTENANCE BLDG. DEMO EAST ELEVATION
A1.02 1/8" = 1'-0"

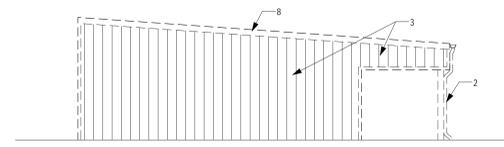

5 MAINTENANCE BLDG. DEMO WEST ELEVATION
A1.02 1/8" = 1'-0"

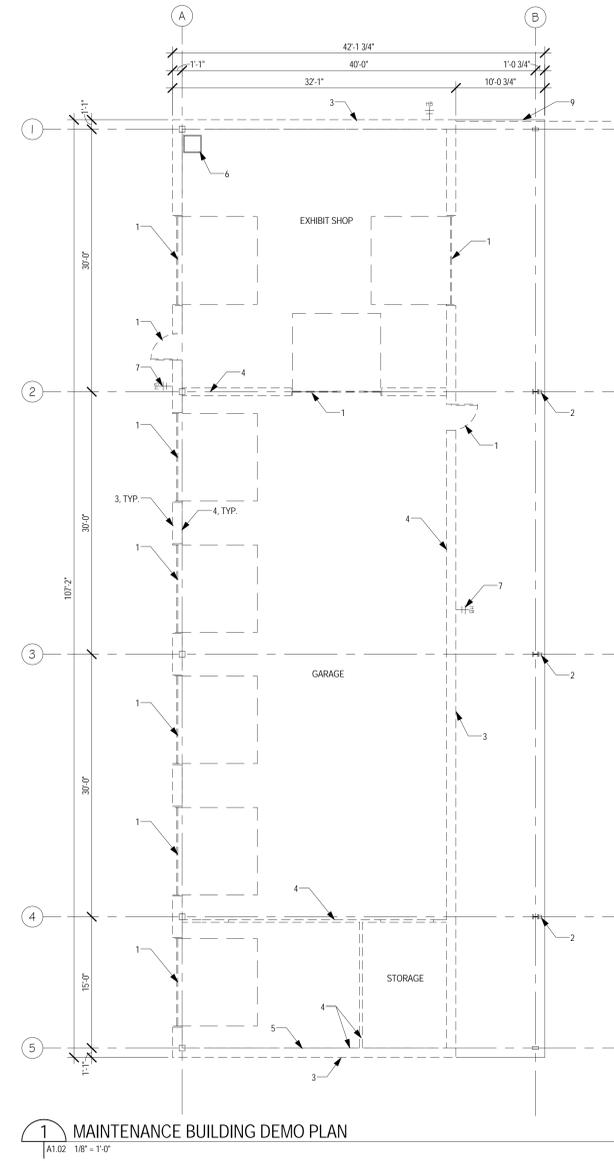

1 MAINTENANCE BUILDING DEMO PLAN
A1.02 1/8" = 1'-0"









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GENERAL NOTES:
 • MECHANICALLY CLEAN, PRIME, AND PAINT ALL STEEL COMPONENTS INCLUDING COLUMNS, BEAMS, AND FRAMING.

- KEY NOTES:**
1. DOUBLE STACKED INSULATED FLOOD VENTS. SEE DETAIL 5, 6 & 7 IN SHEET A2.01.
 2. 3/4" PLYWOOD SHELVES W/ 2x4 WOOD STUD STRUCTURE TO MATCH EXISTING.
 3. 4" x 5" RECT. METAL DOWNSPOUTS.
 4. 6"x6-1/2" RECT. METAL GUTTER.
 5. METAL ROOF PANELS.
 6. METAL WALL PANELS.



Room Schedule									
Number	Name	Floor Finish	Base Finish	Ceiling Finish	North Wall Finish	East Wall Finish	South Wall Finish	West Wall Finish	Remarks
101	STORAGE	Sealed Concrete	N/A	N/A	Unfinished Plywood	Unfinished Plywood	Unfinished Plywood	Unfinished Plywood	
102	STORAGE	Sealed Concrete	N/A	N/A	Unfinished Plywood	Unfinished Plywood	N/A	N/A	

Door Schedule								
Mark	Door Type	Frame Type	Width	Height	Thickness	Fire Rating	Hardware Set	Comments
101A	Hollow Metal	Hollow Metal	3' - 0"	7' - 0"	0' - 1 3/4"		3 Hinges, Lockset, Exit Device, Threshold, Silencers, Closer, Weather Stripping	
101B	Overged Segmented Garage Door	By Manufacturer	10' - 0"	10' - 0"	0' - 2"	N/A	By Manufacturer	Manufactured Assembly
101C	Overged Segmented Garage Door	By Manufacturer	10' - 0"	8' - 0"	0' - 2"	N/A	By Manufacturer	Manufactured Assembly
101D	Overhead Rolling Door	By Manufacturer	10' - 0"	8' - 0"	0' - 2"	N/A	By Manufacturer	Manufactured Assembly
102A	Hollow Metal	Hollow Metal	3' - 0"	7' - 0"	0' - 1 3/4"		3 Hinges, Lockset, Exit Device, Threshold, Silencers, Closer, Weather Stripping	
102B	Overged Segmented Garage Door	By Manufacturer	10' - 0"	10' - 0"	0' - 2"	N/A	By Manufacturer	Manufactured Assembly
102C	Overged Segmented Garage Door	By Manufacturer	10' - 0"	10' - 0"	0' - 2"	N/A	By Manufacturer	Manufactured Assembly
102D	Overged Segmented Garage Door	By Manufacturer	10' - 0"	10' - 0"	0' - 2"	N/A	By Manufacturer	Manufactured Assembly
102E	Overged Segmented Garage Door	By Manufacturer	10' - 0"	10' - 0"	0' - 2"	N/A	By Manufacturer	Manufactured Assembly
102F	Overged Segmented Garage Door	By Manufacturer	10' - 0"	10' - 0"	0' - 2"	N/A	By Manufacturer	Manufactured Assembly
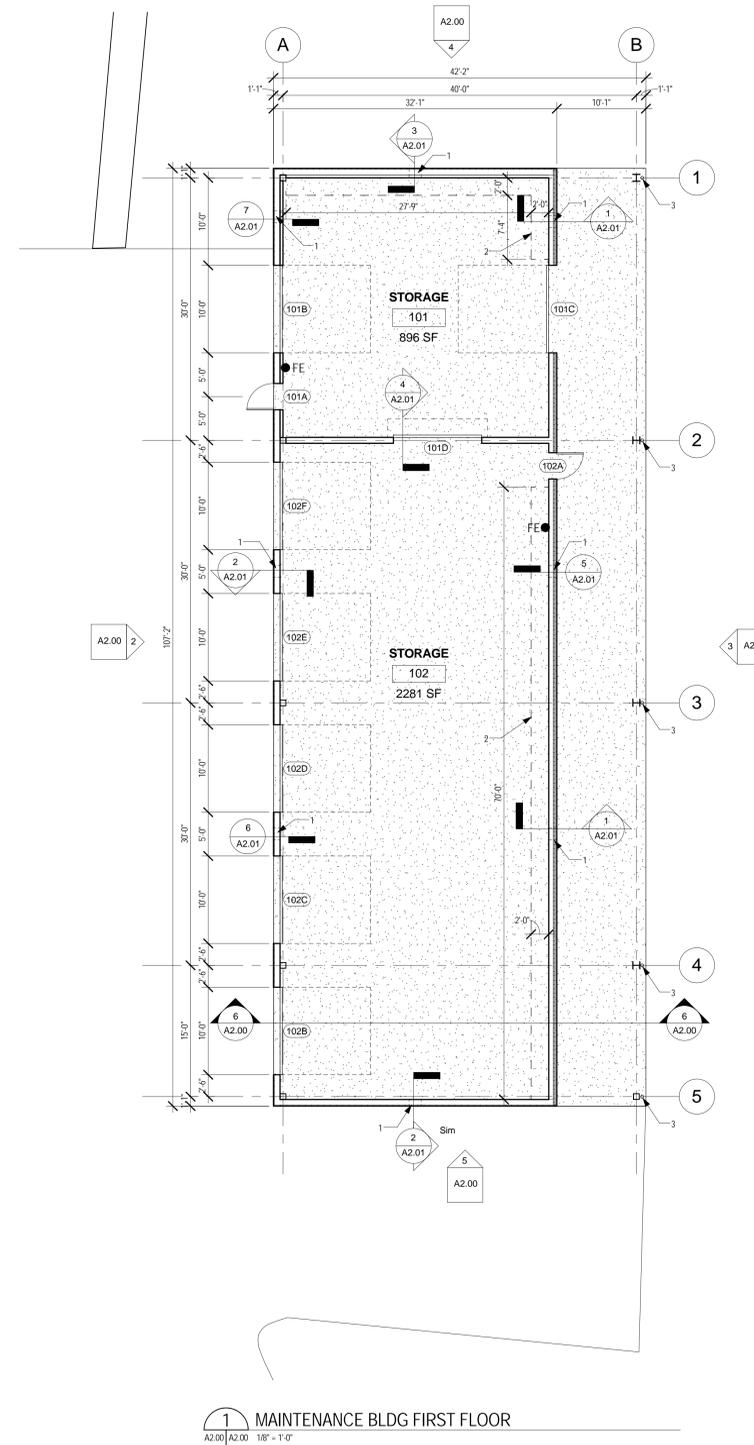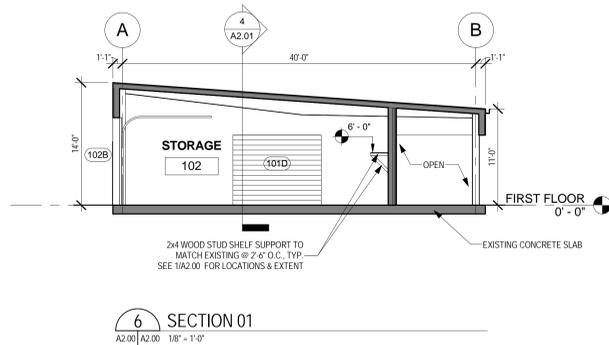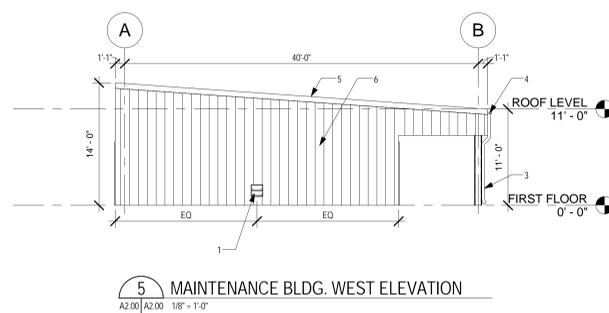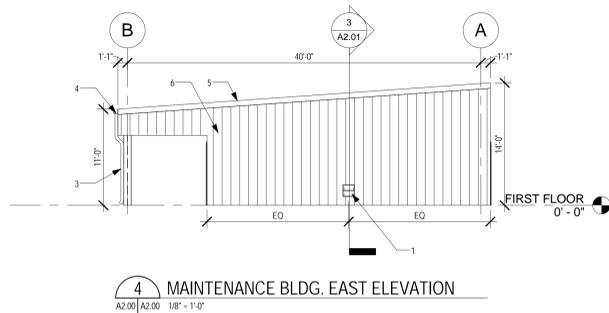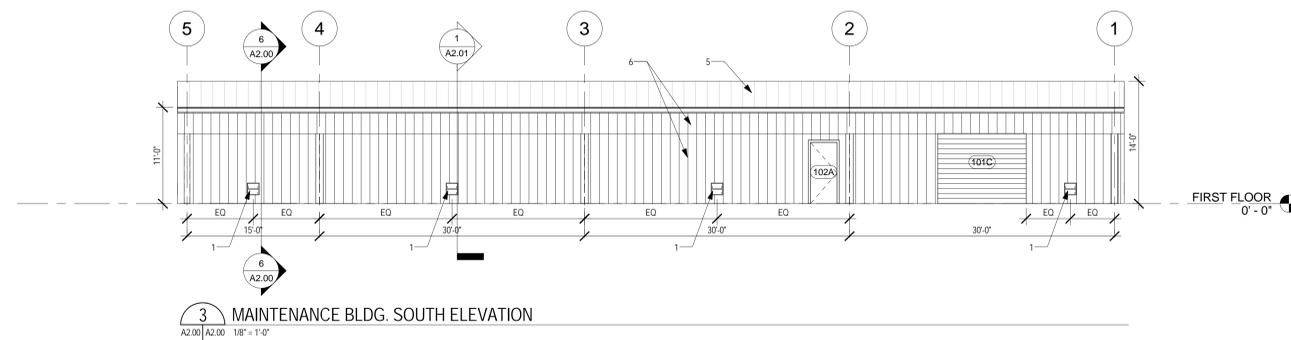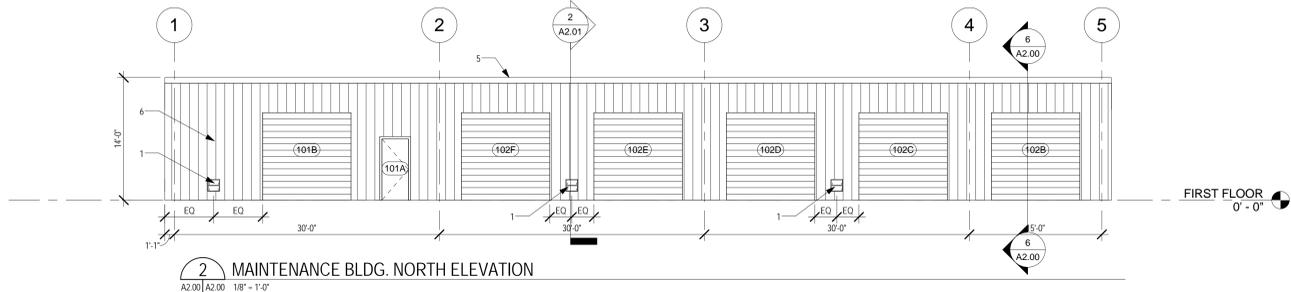
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